


140 MOUNTAIN ROAD TOWN OF COLLINGWOOD

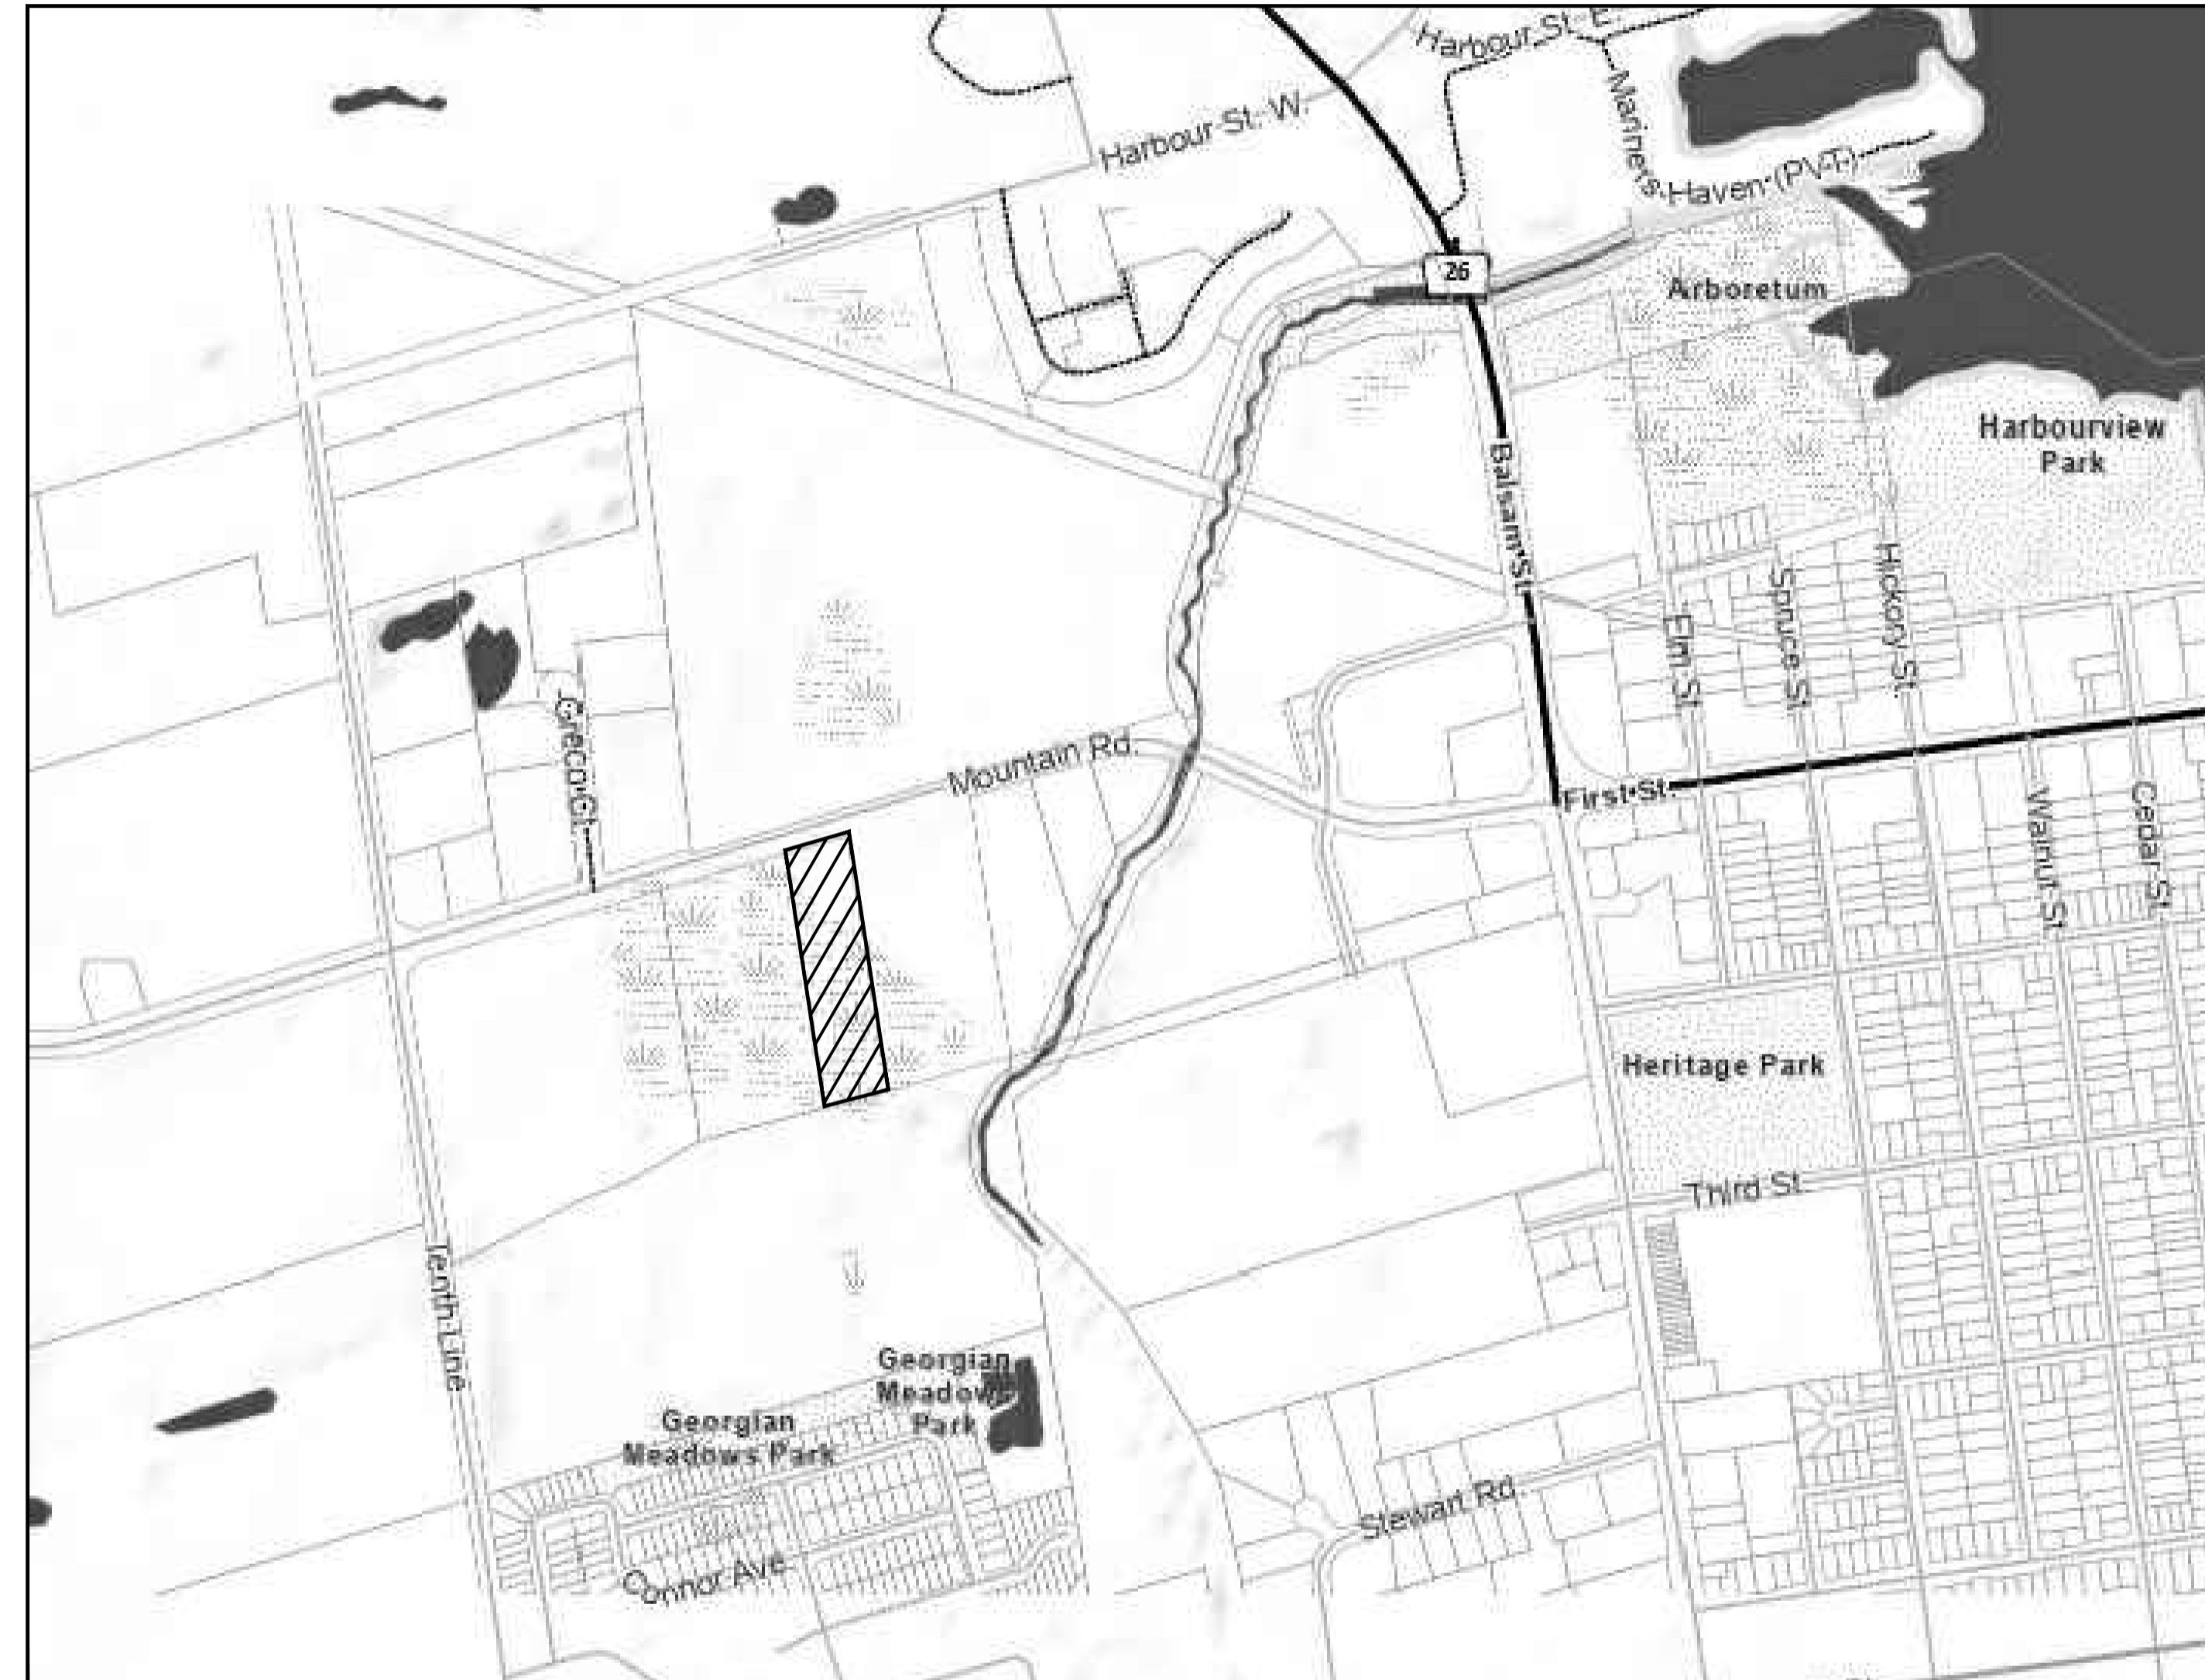

KEY PLAN

ACCEPTED FOR
CONSTRUCTION
TOWN OF COLLINGWOOD
PER _____
DATE: _____



**PROJECT 121036
SITE PLAN APPLICATION
SUBMISSION 4A**

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LEGEND

PROPERTY LINE	
EXISTING EDGE OF ASPHALT	
EXISTING/FUTURE EDGE OF GRAVEL	
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EXISTING DITCH/DIRECTION OF FLOW	
PROPOSED DITCH/DIRECTION OF FLOW	
EXISTING SANITARY SEWER/SIZE/DIRECTION OF FLOW	
PROPOSED SANITARY SEWER/SIZE/DIRECTION OF FLOW	
EXISTING WATERMAIN/SIZE	
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EXISTING STORM SEWER/SIZE/DIRECTION OF FLOW	
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EXISTING CULVERT	
PROPOSED CULVERT	
PROPOSED SWALE LOCATION	
EXISTING FENCELINE	
EXISTING TREELINE	
EXISTING CONTOUR	
EXISTING GROUND ELEVATION	
PROPOSED GROUND ELEVATION	
EXISTING GRADING DIRECTION	
PROPOSED DRAINAGE DIRECTION	
PROPOSED FLOW DIRECTION	
EXISTING/FUTURE FLOW DIRECTION	
PROPOSED SWALE LOCATION	
EXISTING TEMPORARY BENCHMARK	
EXISTING STANDARD IRON BAR	
EXISTING BOREHOLE/NUMBER	
EXISTING/PROPOSED HYDRO TRANSFORMER & CONCRETE VAULT	

EXISTING/PROPOSED CABLE PEDESTAL	
CABLE - CABINET/VAULT/VARIOUS MODELS	
EXISTING/PROPOSED BELL PEDESTAL	
EXISTING HYDRO POLE	
EXISTING HYDRO GUY WIRE	
EXISTING/PROPOSED LIGHT STANDARD	
EXISTING/PROPOSED TRAFFIC SIGN	
PROPOSED STOP SIGN	
PROPOSED STREET NAME SIGN	
EXISTING DECIDUOUS TREE	
EXISTING CONIFEROUS TREE	
EXISTING DECIDUOUS / CONIFEROUS TREE TO BE REMOVED	
EXISTING SANITARY MAINTENANCE HOLE/NUMBER	
PROPOSED WATER VALVE	
EXISTING STORM MAINTENANCE HOLE	
PROPOSED RIP-RAP	
PROPOSED STRAW BALE FLOW CHECK DAM	
PROPOSED HEAVY DUTY SILT FENCE	
PROPOSED ACCESS DOOR	
PROPOSED RETAINING WALL (BY OTHERS)	

ACCEPTED FOR
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TOWN OF COLLINGWOOD

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BENCHMARKS
TBM2 - ELEVATION 189.765
NAIL & WASHER ON NORTH FACE OF HYDRO POLE LOCATED ON NORTH SIDE OF MOUNTAIN ROAD JUST WEST OF EXISTING ACCESS TO SITE.

NOTES
LEGAL INFORMATION SHOWN FROM REGISTERED PLAN 51R-41847 BY ZUBEK, EMO, PATTEN & THOMSEN LIMITED, DATED NOVEMBER 16, 2018 AND SIGNED BY PAUL R. THOMSEN.

No.	REVISION DESCRIPTION	DATE
1.	FIRST SUBMISSION	DEC 21/22
2.	SECOND SUBMISSION	AUG XX/23
3.	THIRD SUBMISSION	JAN 26/24
4.	FOURTH SUBMISSION	APR 4/24
5.	SUBMISSION 4A	APR 23/24

ENGINEER STAMP

**140 MOUNTAIN ROAD
TOWN OF COLLINGWOOD**

DRAWING INDEX AND LEGEND

		DESIGN: MR/KRL	FILE: 121036	DWG:
		DRAWN: MR/KRL	DATE: JUN 2022	IN-1
CHECK: KRS	SCALE: NTS			

SILTATION & EROSION CONTROL:

- ALL SEDIMENT AND EROSION CONTROL MEASURES SHALL BE INSTALLED PRIOR TO THE COMMENCEMENT OF CONSTRUCTION AND SHALL REMAIN IN PLACE UNTIL ALL DISTURBED AREAS HAVE BEEN STABILIZED. SEDIMENT AND EROSION CONTROL MEASURES THAT ARE DESIGNED TO CONTROL RUNOFF FROM SPECIFIC AREAS MUST BE INSTALLED PRIOR TO ANY DISTURBANCE OF THAT PART OF THE SITE. THE LOCATION OF ALL SILTATION AND EROSION CONTROL WORKS TO BE REVIEWED ON SITE AND MAY BE REVISED AS DIRECTED BY THE ENGINEER.
- THE CONTRACTOR SHALL HAVE MATERIALS AVAILABLE ON-SITE TO REPAIR SEDIMENT AND EROSION CONTROL MEASURES IN THE EVENT OF UNFORESEEN CONDITIONS: HIGH WATER, EXTREME RAINFALL EVENTS, ETC.
- ALL EROSION AND SEDIMENT CONTROL MEASURES MUST BE INSPECTED, CLEANED AND MAINTAINED BY THE CONTRACTOR AFTER EACH STORM EVENT. ALL WORKS WILL BE INSPECTED BY THE ENGINEER BI-WEEKLY AND AFTER EACH MAJOR STORM EVENT.
- CONSTRUCTION OF ALL SILTATION AND EROSION CONTROL WORKS ARE TO BE IN ACCORDANCE WITH THE FOLLOWING STEPS:
 - INSTALL STONE MUD MAT AS PER DETAIL.
 - INSTALL SILT FENCE AS PER NOTTAWASAGA VALLEY CONSERVATION AUTHORITY DRAWING BSD-23 DRAFT.
 - INSTALL INTERCEPTOR SWALE ALONG PROPERTY LINE COMPLETED WITH STRAW BALE FLOW CHECKS (OPSD 219.180) AND SEDIMENT TRAP AT OUTLET (OPSD 219.220).
 - INSTALL TEMPORARY CATCH BASIN SEDIMENT TRAPS ON ALL NEW CATCH BASIN STRUCTURES. SEDIMENT TRAPS TO BE RECTANGULAR CBST BY LAYFIELD OR APPROVED EQUAL. ALL CATCH BASINS TO REMAIN SCREENED UNTIL BASE COURSE ASPHALT IS PLACED AND ALL GRADING IS COMPLETE.
- ALL CONSTRUCTION VEHICLES TO ACCESS SITE USING THE DESIGNATED CONSTRUCTION ENTRANCE.
- EROSION AND SEDIMENT CONTROL MEASURES TO BE REMOVED BY THE CONTRACTOR ONCE GROUND COVER IS ESTABLISHED AND LANDSCAPING IS COMPLETE AND AS APPROVED BY THE ENGINEER.
- STOCKPILE LOCATIONS ARE TO BE APPROVED BY THE ENGINEER.
- PROVIDE SNOW FENCE OR APPROVED EQUAL ACROSS ALL CONSTRUCTION ENTRANCES DURING PERIODS OF INACTIVITY.
- CONSTRUCTION AREAS THAT EXCEED 30 DAYS OF INACTIVITY SHALL BE STABILIZED BY SEEDING IN ACCORDANCE WITH THE EROSION AND SEDIMENT CONTROL GUIDELINE FOR URBAN CONSTRUCTION AND/OR AS DIRECTED BY THE TOWNSHIP. THIS IS TO INCLUDE STOCKPILES OF FILL AND TOPSOIL.
- INSTALL THE PROTECTIVE/SILT FENCE BARRIER AT OR OUTSIDE THE DRIPLINE OF PROTECTED TREES, WHICH IS DEFINED AS THE CIRCLE THAT COULD BE DRAWN ON THE SOIL AROUND A TREE DIRECTLY UNDER THE TIPS OF ITS OUTERMOST AND WIDEST BRANCHES.
- OBTAIN TOWN APPROVAL OF THE FENCE LAYOUT PRIOR TO COMMENCING REMOVALS WORK.
- NO CONSTRUCTION ACTIVITY, INCLUDING GRADE CHANGES, EXCAVATIONS, ROOT CUTTING, STORAGE OF MATERIALS OR FILL, MOVEMENT/STORAGE OF VEHICLES, OR SURFACE TREATMENTS OF ANY KIND ARE PERMITTED WITHIN TREE PROTECTION AREA.
- PROTECT VEGETATION AND ROOT SYSTEMS FROM DAMAGE, COMPACTION, AND CONTAMINATION RESULTING FROM CONSTRUCTION AND KEEP FREE OF CONSTRUCTION MATERIAL AND DEBRIS.
- CLEANLY CUT ALL ROOTS OUTSIDE TREE PROTECTION AREAS THAT BECOME EXPOSED DURING CONSTRUCTION.
- PROTECTIVE FENCE BARRIERS MUST REMAIN IN EFFECTIVE CONDITION UNTIL ALL SITE ACTIVITIES, INCLUDING LANDSCAPING, ARE COMPLETED.
- SEE TREE PRESERVATION PLAN (DRAWING TP-1) FOR ADDITIONAL LAYOUT AND MITIGATION MEASURES WHERE THE SILT FENCE IS ADJACENT TO TREE PROTECTION AREAS.

STONE SIZE
THE STONE PAD SHALL BE A MIN. 450 mm THICK. USE 50# mm STONE OR RECLAIMED CONCRETE EQUIVALENT FOR FIRST 15 m FROM ADJACENT ROAD & 150 mm# STONE FOR REMAINDER OF STONE PAD.

LENGTH
AS REQUIRED BUT NOT LESS THAN 30 m.


WIDTH
5 m MIN. BUT NOT LESS THAN THE WIDTH AT POINTS WHERE INGRESS AND EGRESS OCCURS.

GEOTEXTILE FABRIC
TERRAFIX 270R OR EQUAL TO BE PLACED OVER THE ENTIRE AREA PRIOR TO PLACING STONE.


SURFACE WATER
ALL SURFACE WATER FLOWING OR DIRECTED TOWARD CONSTRUCTION ENTRANCES SHALL BE PIPED ACROSS THE ENTRANCE.

MAINTENANCE
THE CONTRACTOR SHALL MAINTAIN THE ENTRANCE IN A CONDITION WHICH WILL PREVENT TRACKING OR FLOWING OF SEDIMENT ONTO PUBLIC RIGHT-OF-WAY. THIS MAY REQUIRE PERIODIC DRESSING WITH ADDITIONAL STONE AS CONDITIONS DEMAND AND REPAIR AND/OR CLEANOUT OF ANY MEASURES USED TO TRAP SEDIMENT. ALL SEDIMENT SPILLED, DROPPED, WASHED OR TRACKED ONTO PUBLIC RIGHT-OF-WAY MUST BE REMOVED IMMEDIATELY BY THE CONTRACTOR. UPON OBSERVATION OF CONTINUOUS MUD TRACKING ONTO ADJACENT STREETS, THE STONE MAT IS TO BE FULLY REPLACED. INSPECTION AND REQUIRED MAINTENANCE AFTER EACH RAIN EVENT SHALL BE PROVIDED BY THE CONTRACTOR.

WASHING
WHEELS SHALL BE CLEANED TO REMOVE SEDIMENT PRIOR TO ENTRANCE ONTO PUBLIC RIGHT-OF-WAY. WHEN WASHING IS REQUIRED, IT SHALL BE DONE ON AN AREA STABILIZED WITH STONE AND WHICH DRAINS INTO AN APPROVED SEDIMENT TRAPPING DEVICE.

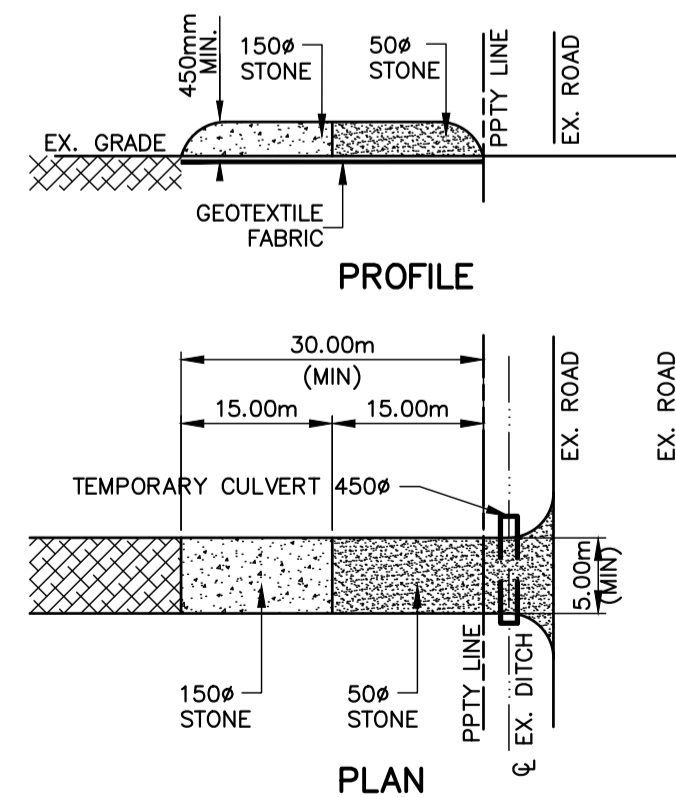


1 SC-1 STONE MUD MAT DETAIL N.T.S.

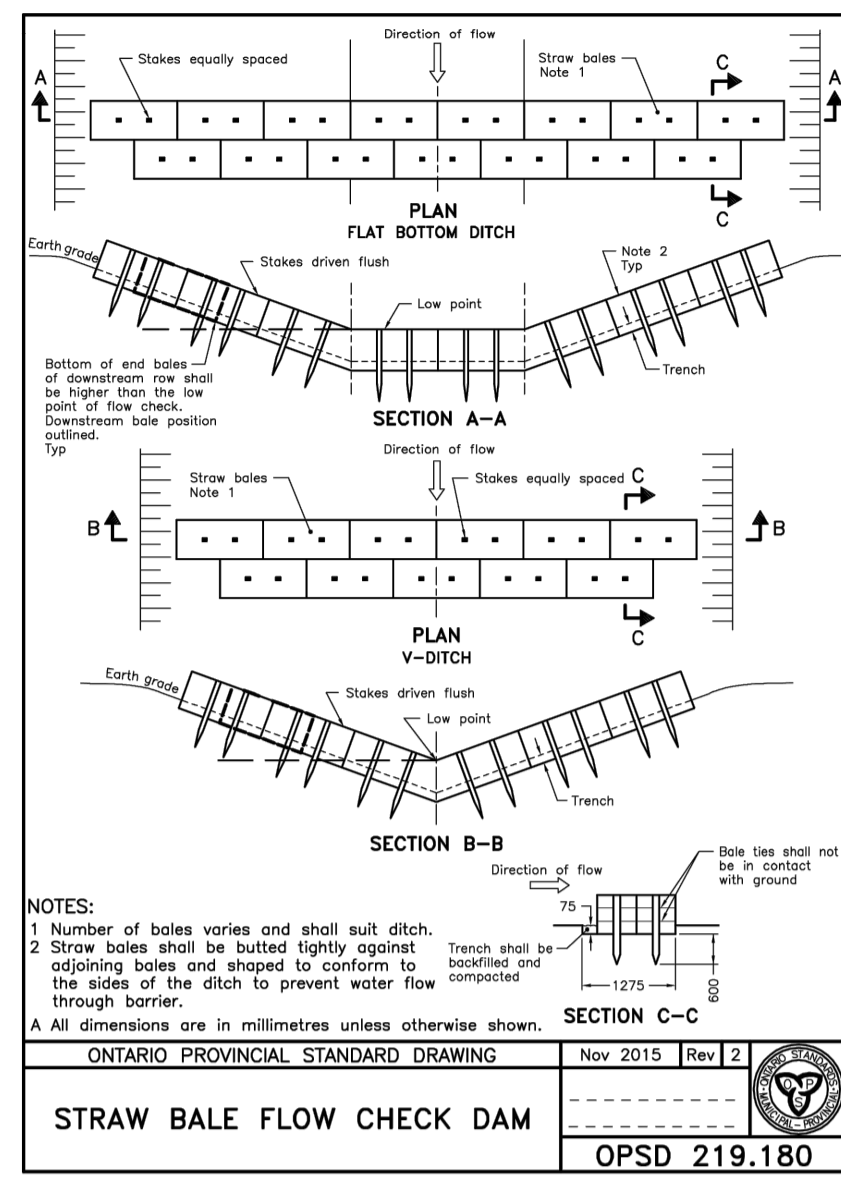


NOTES:
1. Number of bales varies and shall suit ditch.
2. Straw bales shall be baled tightly against adjoining bales and shaped to conform to the sides of the ditch to prevent water flow through barrier.
A. All dimensions are in millimetres unless otherwise shown.

ONTARIO PROVINCIAL STANDARD DRAWING Nov 2015 Rev 2
STRAW BALE FLOW CHECK DAM OPSD 219.180

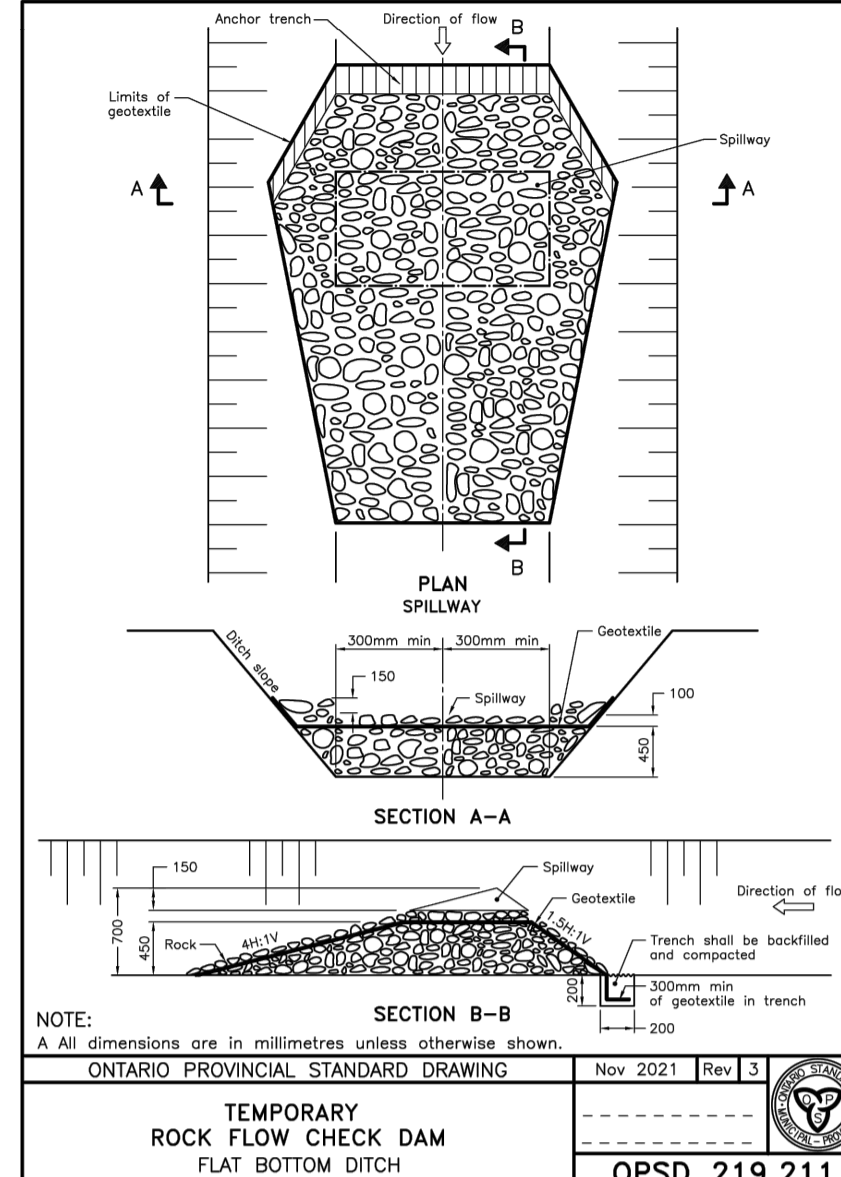


NOTE:
A. All dimensions are in millimetres unless otherwise shown.

ONTARIO PROVINCIAL STANDARD DRAWING Nov 2021 Rev 3
TEMPORARY ROCK FLOW CHECK DAM FLAT BOTTOM DITCH OPSD 219.211

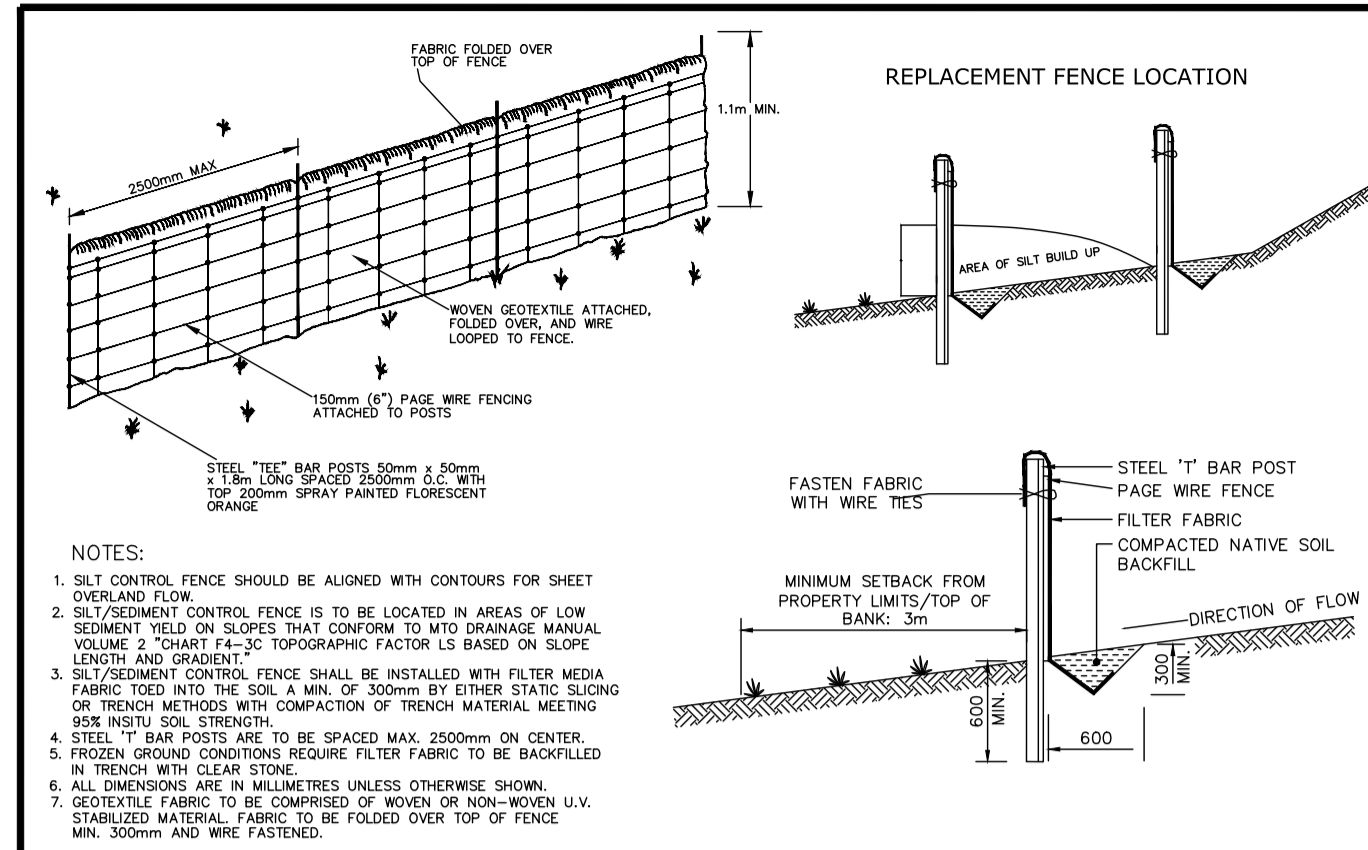

NOTES:
1. SILT CONTROL FENCE SHOULD BE ALIGNED WITH CONTOURS FOR SHEET OVERLAND FLOW.
2. SILTATION CONTROL FENCE IS TO BE LOCATED IN AREAS OF LOW SEDIMENT YIELD ON SLOPES THAT CONFORM TO MTD DRAINAGE MANUAL VOLUME 2 "CONSTANT F-3-C" TOPOGRAPHIC FACTOR IS BASED ON SLOPE LENGTH AND GRADIENT.
3. SILTATION CONTROL FENCE SHALL BE INSTALLED WITH FILTER MEDIA FABRIC TIED INTO THE SOIL A MIN. OF 300mm BY EITHER STATIC SLICING OR TRENCH METHOD WITH COMPACTION OF TRENCH MATERIAL MEETING SUE NORTH SOIL STRENGTH.
4. STEEL T BAR POSTS ARE TO BE SPACED MAX 2500mm ON CENTER.
5. FROZEN GROUND CONDITIONS REQUIRE FILTER FABRIC TO BE BACKFILLED.
6. ALL DIMENSIONS ARE IN MILLIMETRES UNLESS OTHERWISE SHOWN.
7. GEOTEXTILE FABRIC TO BE COMPRISED OF WOVEN OR NON-WOVEN U.V. STABILIZED MATERIAL FABRIC TO BE FOLDED OVER TOP OF FENCE MIN. 300mm AND WIRE FASTENED.

Nottawasaga Valley Conservation Authority
TYPICAL DETAIL OF SILT/SEDIMENT FENCE
APRD: DATE: 03.03.06
DRAWN: A.S.C SCALE: NTS
NO. REVISION APR'D DATE BSD-23 DRAFT

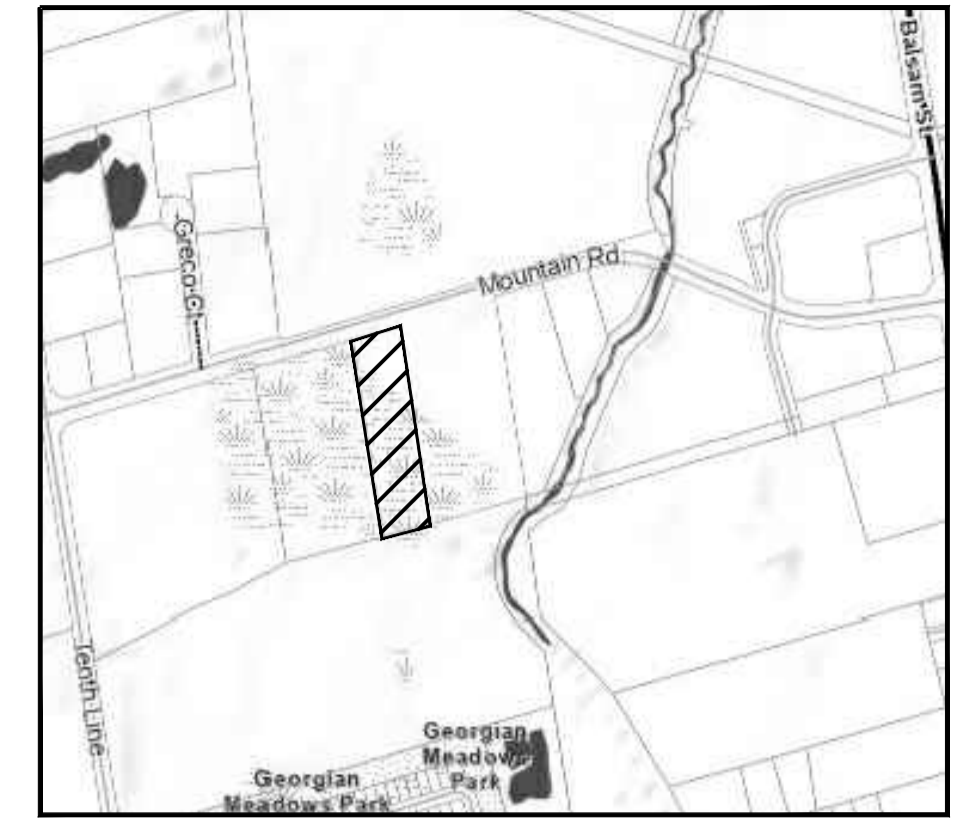


KEY PLAN

- LEGEND**
- SUBJECT PROPERTY BOUNDARY
 - PROPOSED STRAW BALE FLOW CHECK
 - PROPOSED ROCK FLOW CHECK
 - PROPOSED SILT FENCE CONSTRUCTION
 - PROPOSED MUD MAT
 - EXISTING OVERLAND FLOW ROUTE
 - PROPOSED CONSTRUCTION ACCESS
 - PROPOSED SWALE FLOW DIRECTION



180 MOUNTAIN ROAD (CONSTRUCTION IN PROGRESS)

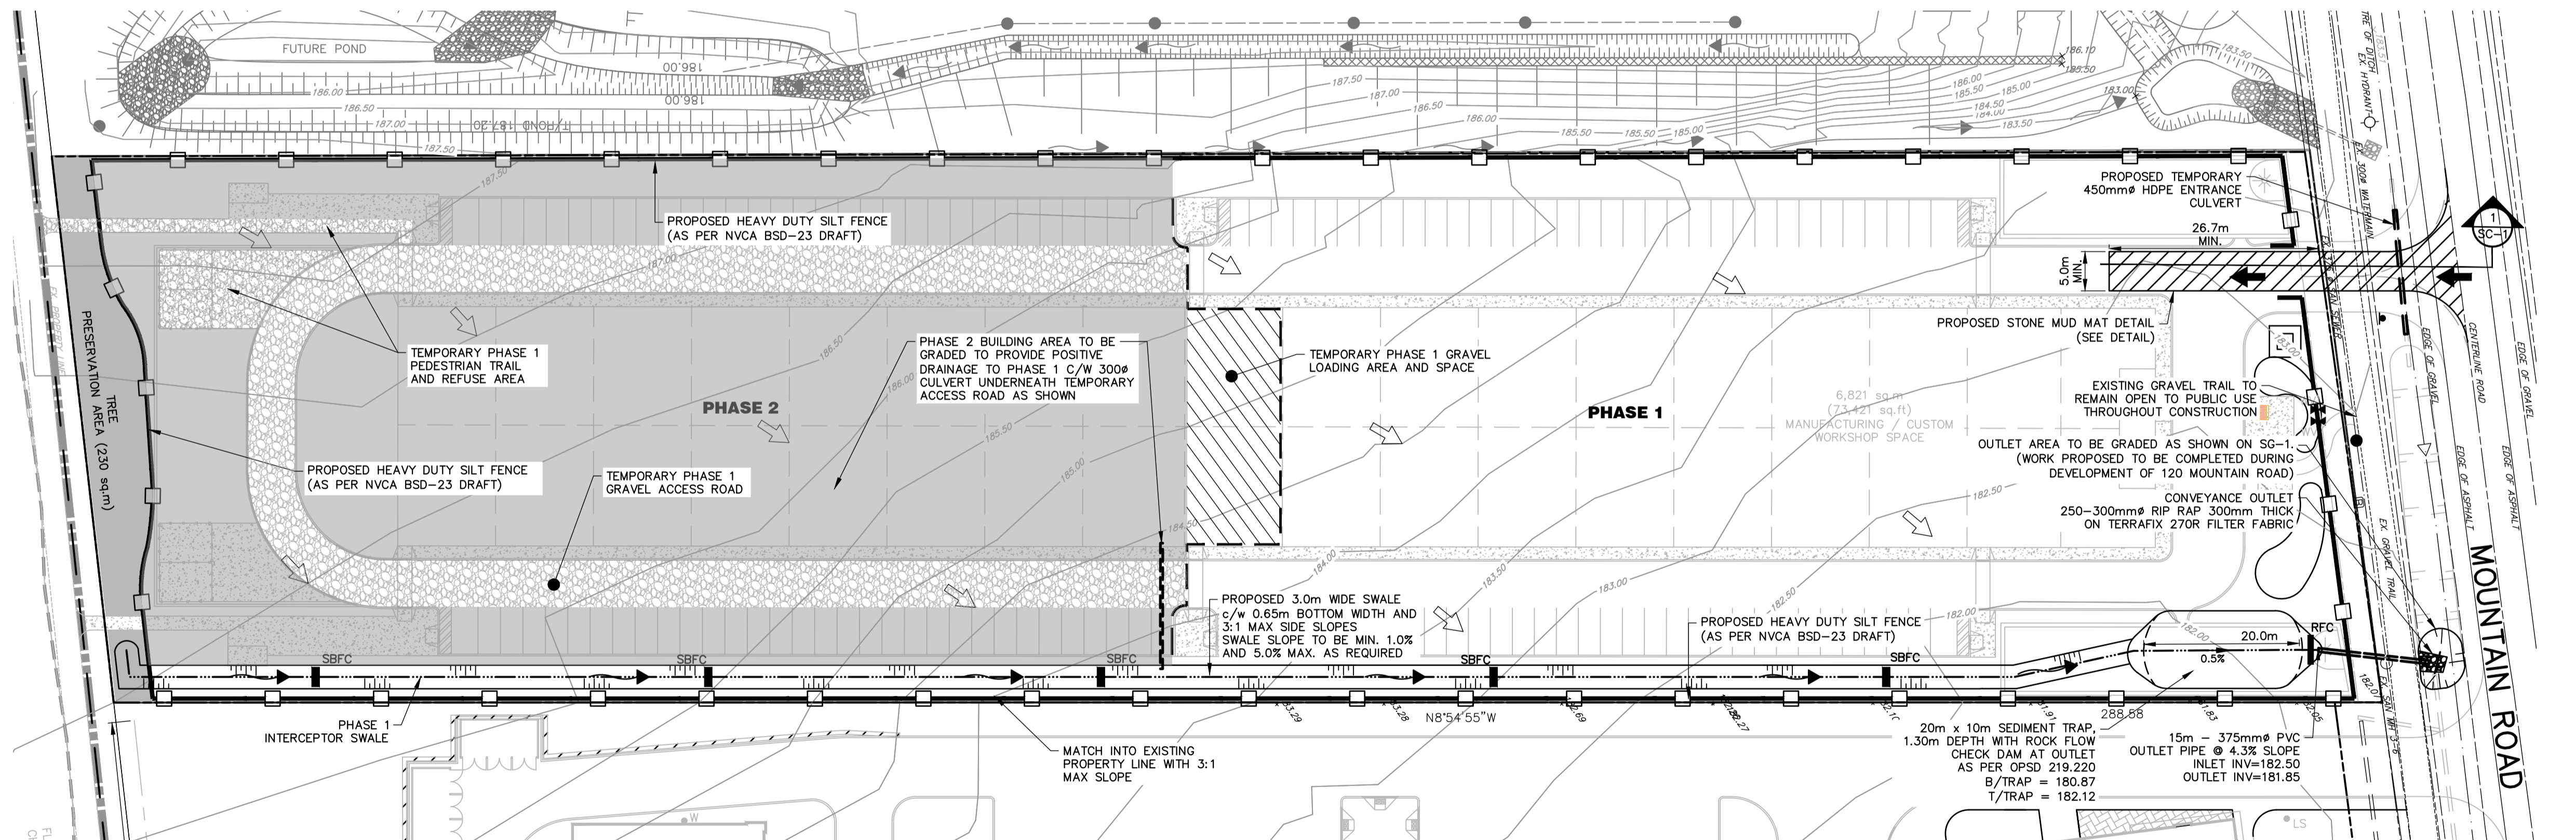

120 MOUNTAIN ROAD (APPROVED)

ACCEPTED FOR CONSTRUCTION TOWN OF COLLINGWOOD
PER _____
DATE: _____

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BENCHMARKS
TBM2 - ELEVATION 189.765
NAIL & WASHER ON NORTH FACE OF HYDRO POLE LOCATED ON NORTH SIDE OF MOUNTAIN ROAD JUST WEST OF EXISTING ACCESS TO SITE.

NOTES
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5.	SUBMISSION 4A	APR 23/24	

140 MOUNTAIN ROAD TOWN OF COLLINGWOOD

SILT AND EROSION CONTROL PLAN

DESIGN: MR/KRL FILE: 121036 DWG:
DRAWN: MR/KRL DATE: JUN 2022 **SC-1**
CHECK: KRS SCALE: 1:500

TATHAM ENGINEERING

SITE STATISTICS

MUNICIPAL ADDRESS: 140 MOUNTAIN ROAD
 ZONING PROVISIONS (ZONE M5 - INDUSTRIAL)

	REQUIRED	PROVIDED
MINIMUM LOT AREA	2,000 m ²	20,169m ²
MINIMUM LOT FRONTAGE	30.0m	59.8m
MINIMUM FRONT YARD	12.0m	22.1m
MINIMUM REAR YARD	7.5m	38.2m
MINIMUM INTERIOR SIDE YARD	6.0m	19.2m
MINIMUM EXTERIOR SIDE YARD	12.0m	N/A
MAXIMUM BUILDING HEIGHT	15.0m	12.67m
MAXIMUM LOT COVERAGE	50%	32.6%
LANDSCAPED AREA		33.2%

PARKING SPACE REQUIREMENTS AS PER TOWN OF COLLINGWOOD ZONING BY-LAW
 CALCULATIONS INCLUDE MAIN FLOOR AREA AND MEZZANINE AREA, GFA (EXCLUDING WASHROOMS AND MECHANICAL ROOMS) = 8,436.9 m²
 ESTIMATED WAREHOUSE/MANUFACTURING AREA: 6,474.2 m² = 65 SPACES (1 SPACE PER 100 m² GFA)
 ESTIMATED OFFICE / OTHER USES AREA: 1,874.7 m² = 56 SPACES (3 SPACES PER 100 m² GFA)
 REQUIRED = 121 SPACES (2.8m x 6.0m MIN.)
 PHASE 1 = 60
 PHASE 2 = 61

BARRIER FREE SPACES (2% OF TOTAL PARKING):
 REQUIRED: 6 SPACE PER 25 PARKING SPACES
 PROVIDED: 4 TYPE A (3.4m x 6.0m C/W 1.5m SHARED AISLE) + 2 TYPE B (2.4M X 6.0M C/W 1.5M SHARED AISLE) = 6 TOTAL
 PHASE 1 = 4 (2 TYPE A & 2 TYPE B)
 PHASE 2 = 2 TYPE A
 TOTAL = 6

TOTAL PARKING SPACES: 128 SPACES (9 EXTRA FOR SNOW STORAGE)
 PHASE 1 = 64
 PHASE 2 = 64


BICYCLE PARKING REQUIRED: 18 SPACES (13.9% OF TOTAL PARKING SPACES)
 BICYCLE PARKING PROVIDED: 20 SPACES
 PHASE 1 = 8
 PHASE 2 = 12

LOADING SPACES:
 REQUIRED: 2 (2 SPACES BETWEEN 7,000m² - 10,000m² GFA)
 PROVIDED: 2 (3.5m x 20.0m w/4.5m VERTICAL CLEARANCE)


TREE CLEARING:
 TOTAL AREA TO BE CLEARED = 19,419 m²
 TREE PRESERVATION AREA REMAINING: 414 m²

WETLAND MITIGATION STATISTICS

AREA OF LOSS = 1,542m²
 AREA OF GAIN = (AREA OF LOSS x 2) + 30m BUFFER AREA = 3,084m² + 3,837m² = 6,921m² * \$120,000/ha = \$83,052

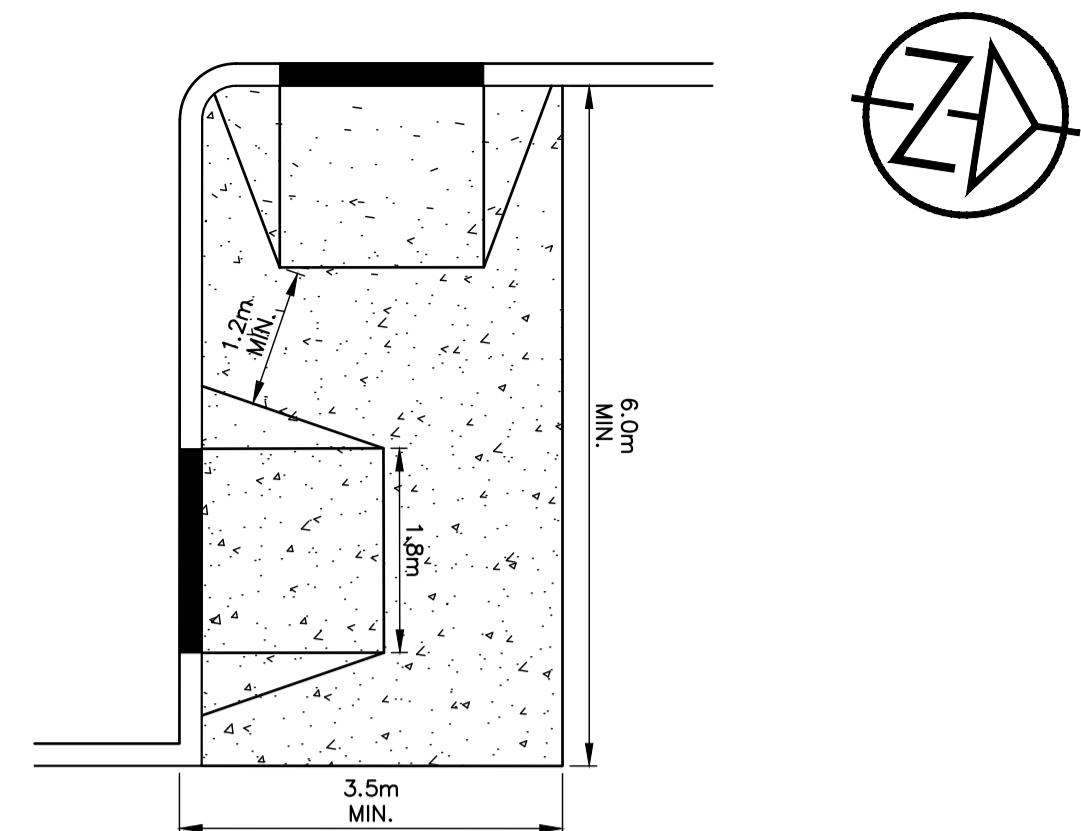


ACCESSIBLE PARKING ACCESS
 NTS

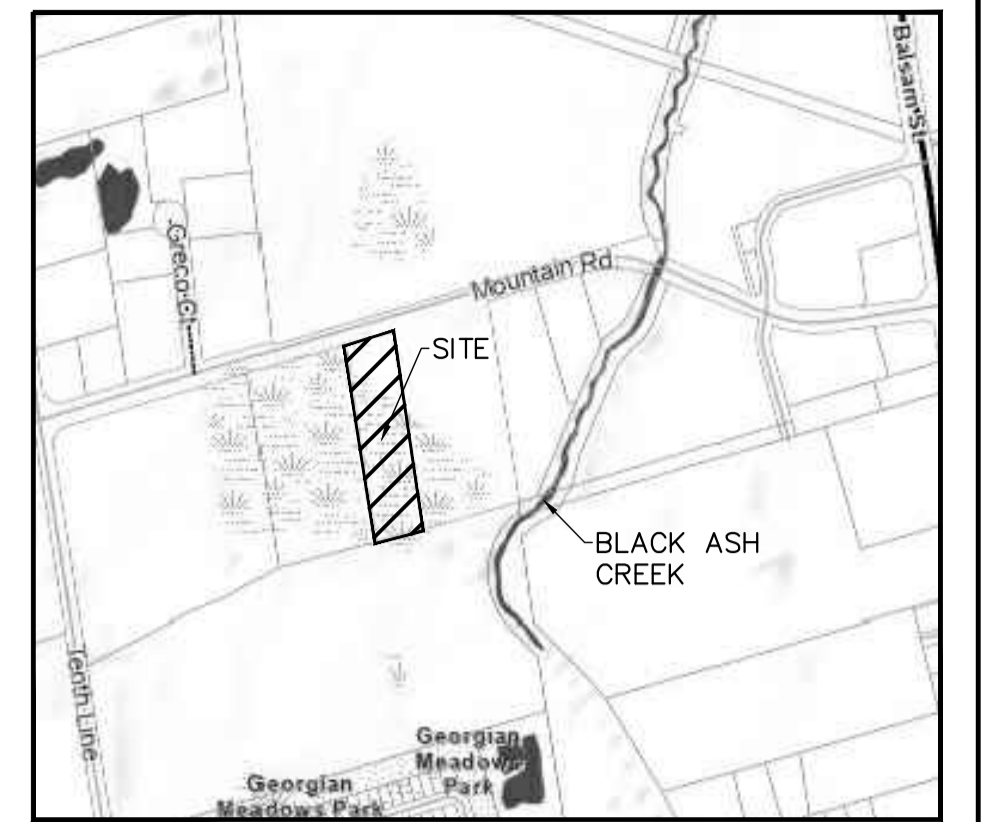

KEY PLAN

180 MOUNTAIN ROAD (CONSTRUCTION IN PROGRESS.)

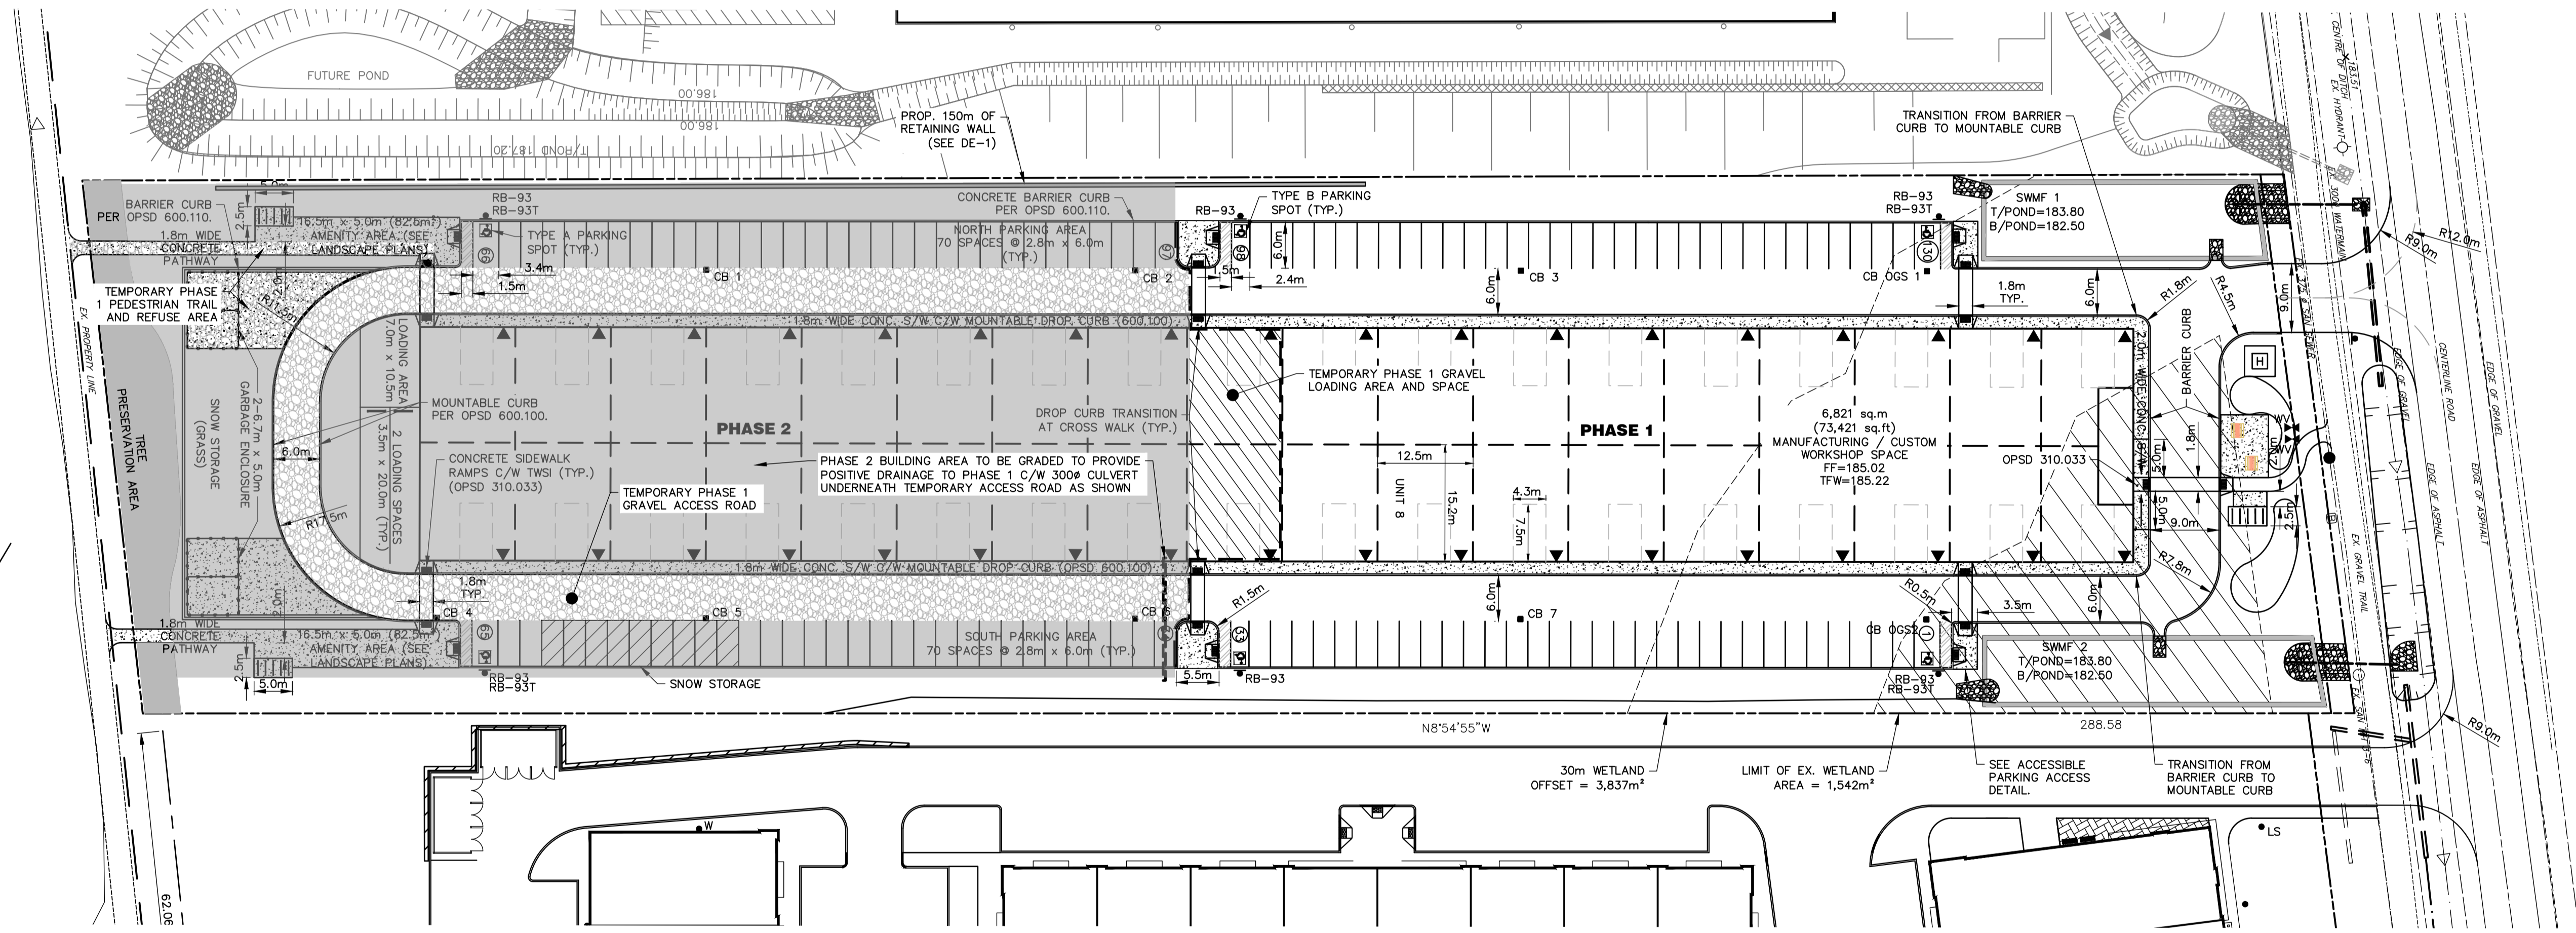

120 MOUNTAIN ROAD (APPROVED.)

ACCEPTED FOR CONSTRUCTION
 TOWN OF COLLINGWOOD
 PER _____
 DATE: _____

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BENCHMARKS
 TBW2 - ELEVATION 189.765
 NAIL & WASHER ON NORTH FACE OF HYDRO POLE LOCATED ON NORTH SIDE OF MOUNTAIN ROAD JUST WEST OF EXISTING ACCESS TO SITE.

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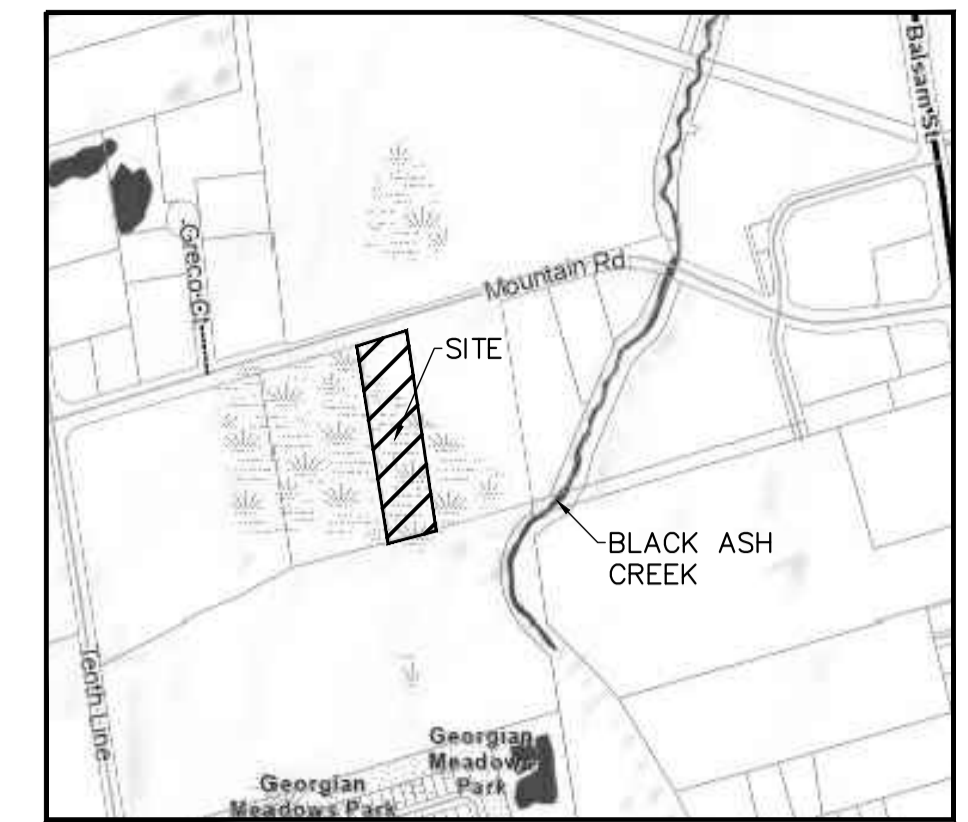
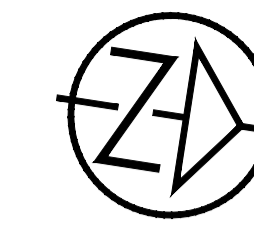
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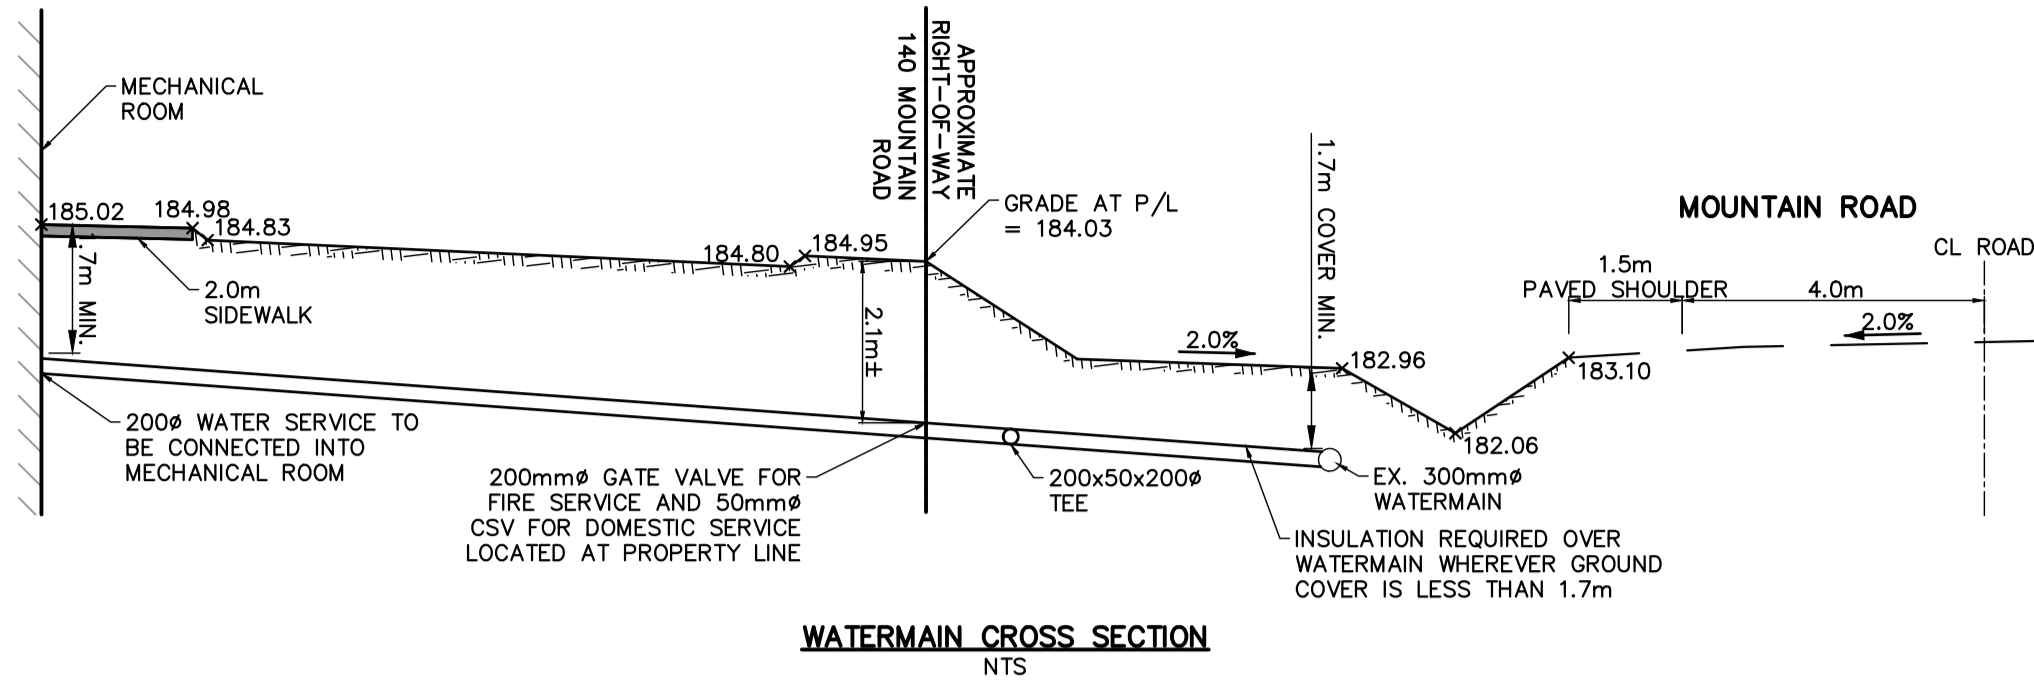
140 MOUNTAIN ROAD
TOWN OF COLLINGWOOD

 SITE PLAN

TATHAM ENGINEERING
 DESIGN: MR/KRL FILE: 121036 DWG:
 DRAWN: MR/KRL DATE: JUN 2022 **SP-1**
 CHECK: KRS SCALE: 1:500




KEY PLAN



WATERMAIN CROSS SECTION NTS

180 MOUNTAIN ROAD (CONSTRUCTION IN PROGRESS)

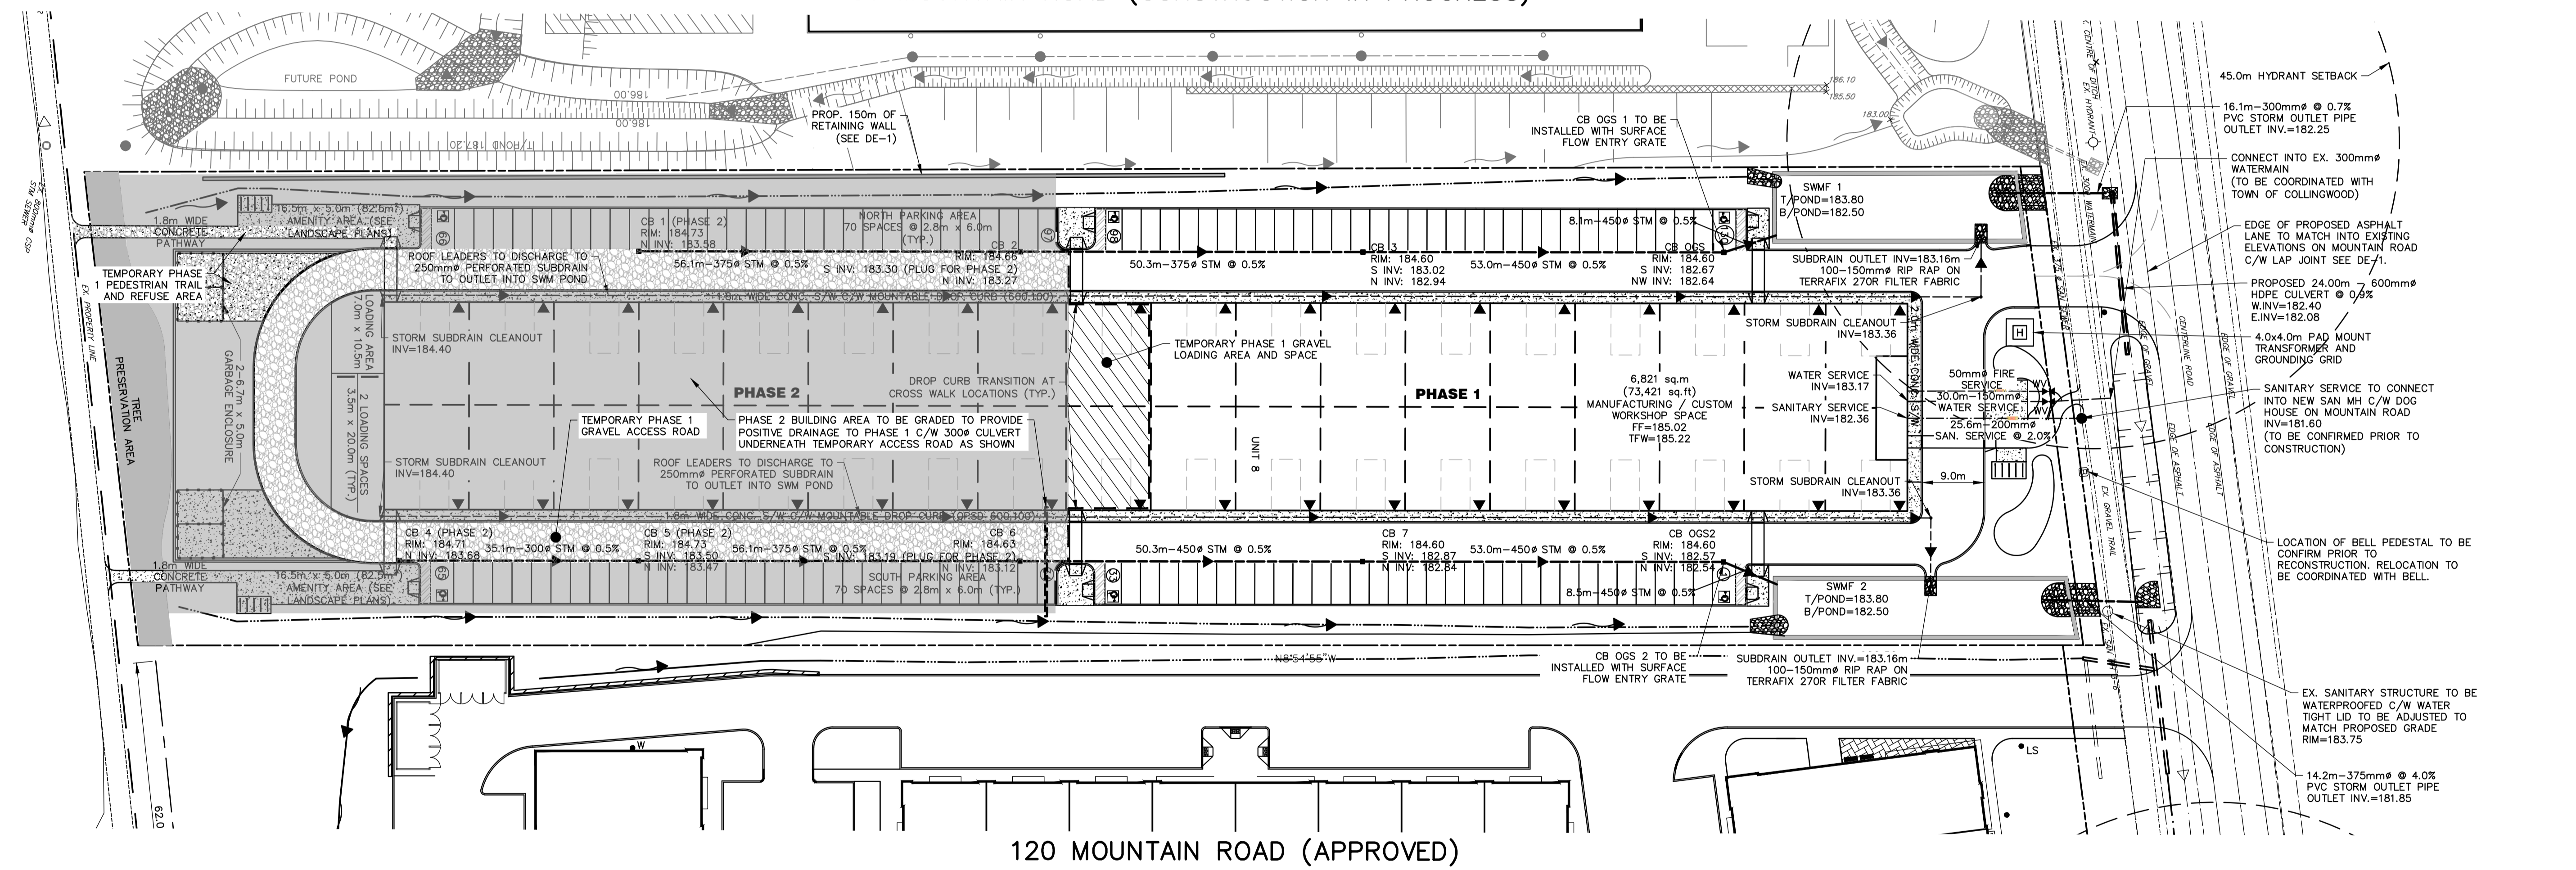

120 MOUNTAIN ROAD (APPROVED)

- 45.0m HYDRANT SETBACK
- 16.1m-300mm ϕ 0.7% PVC STORM OUTLET PIPE OUTLET INV.=182.25
- CONNECT INTO EX. 300mm ϕ WATERMAIN (TO BE COORDINATED WITH TOWN OF COLLINGWOOD)
- EDGE OF PROPOSED ASPHALT LANE TO MATCH INTO EXISTING ELEVATIONS ON MOUNTAIN ROAD C/W LAP JOINT SEE DE-1.
- PROPOSED 24.00m ϕ 0.6% HDPE CULVERT @ 0.6% W.INV.=182.40 E.INV.=182.08
- 4.0x4.0m PAD MOUNT TRANSFORMER AND GROUNDING GRID
- SANITARY SERVICE TO CONNECT INTO NEW SAN MH C/W DOG HOUSE ON MOUNTAIN ROAD INV.=181.60 (TO BE CONFIRMED PRIOR TO CONSTRUCTION)
- LOCATION OF BELL PEDESTAL TO BE CONFIRMED PRIOR TO RECONSTRUCTION. RELOCATION TO BE COORDINATED WITH BELL.
- EX. SANITARY STRUCTURE TO BE WATERPROOFED C/W WATER TIGHT LID TO BE ADJUSTED TO MATCH PROPOSED GRADE RIM=183.75
- 14.2m-375mm ϕ 4.0% PVC STORM OUTLET PIPE OUTLET INV.=181.85

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TOWN OF COLLINGWOOD

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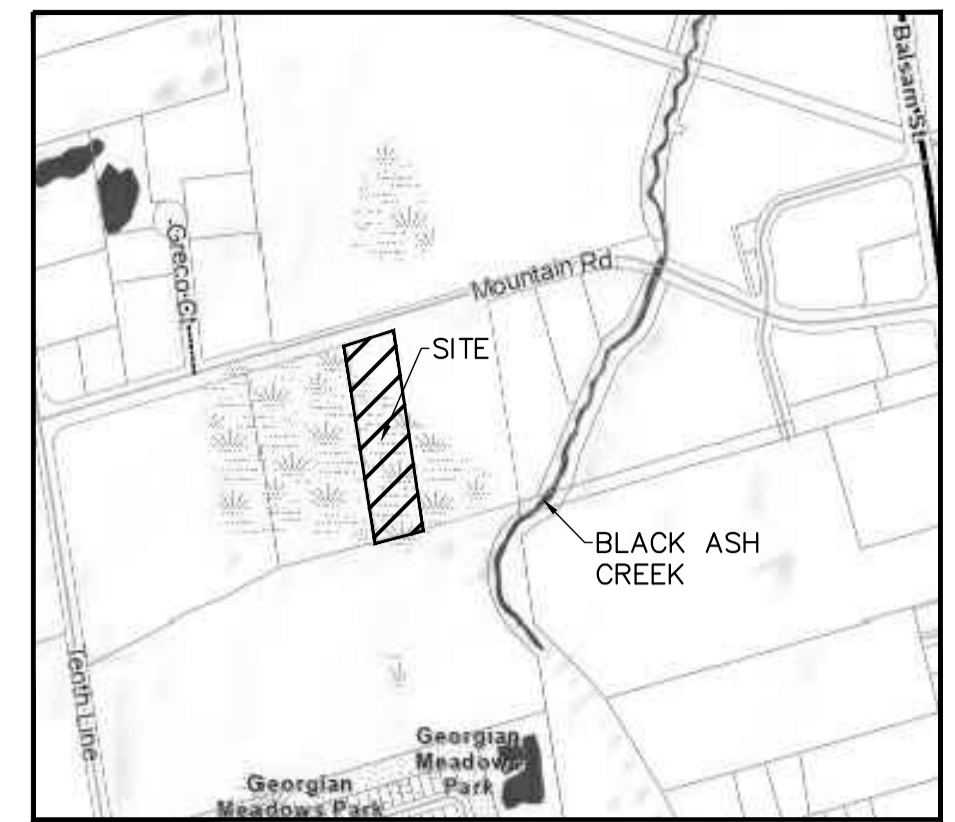
ENGINEER STAMP

**140 MOUNTAIN ROAD
TOWN OF COLLINGWOOD**

SITE SERVICING PLAN


TATHAM ENGINEERING

DESIGN: MR/KRL FILE: 121036 DWG:
DRAWN: MR/KRL DATE: JUN 2022 **SS-1**
CHECK: KRS SCALE: 1:500



KEY PLAN

180 MOUNTAIN ROAD (CONSTRUCTION IN PROGRESS)

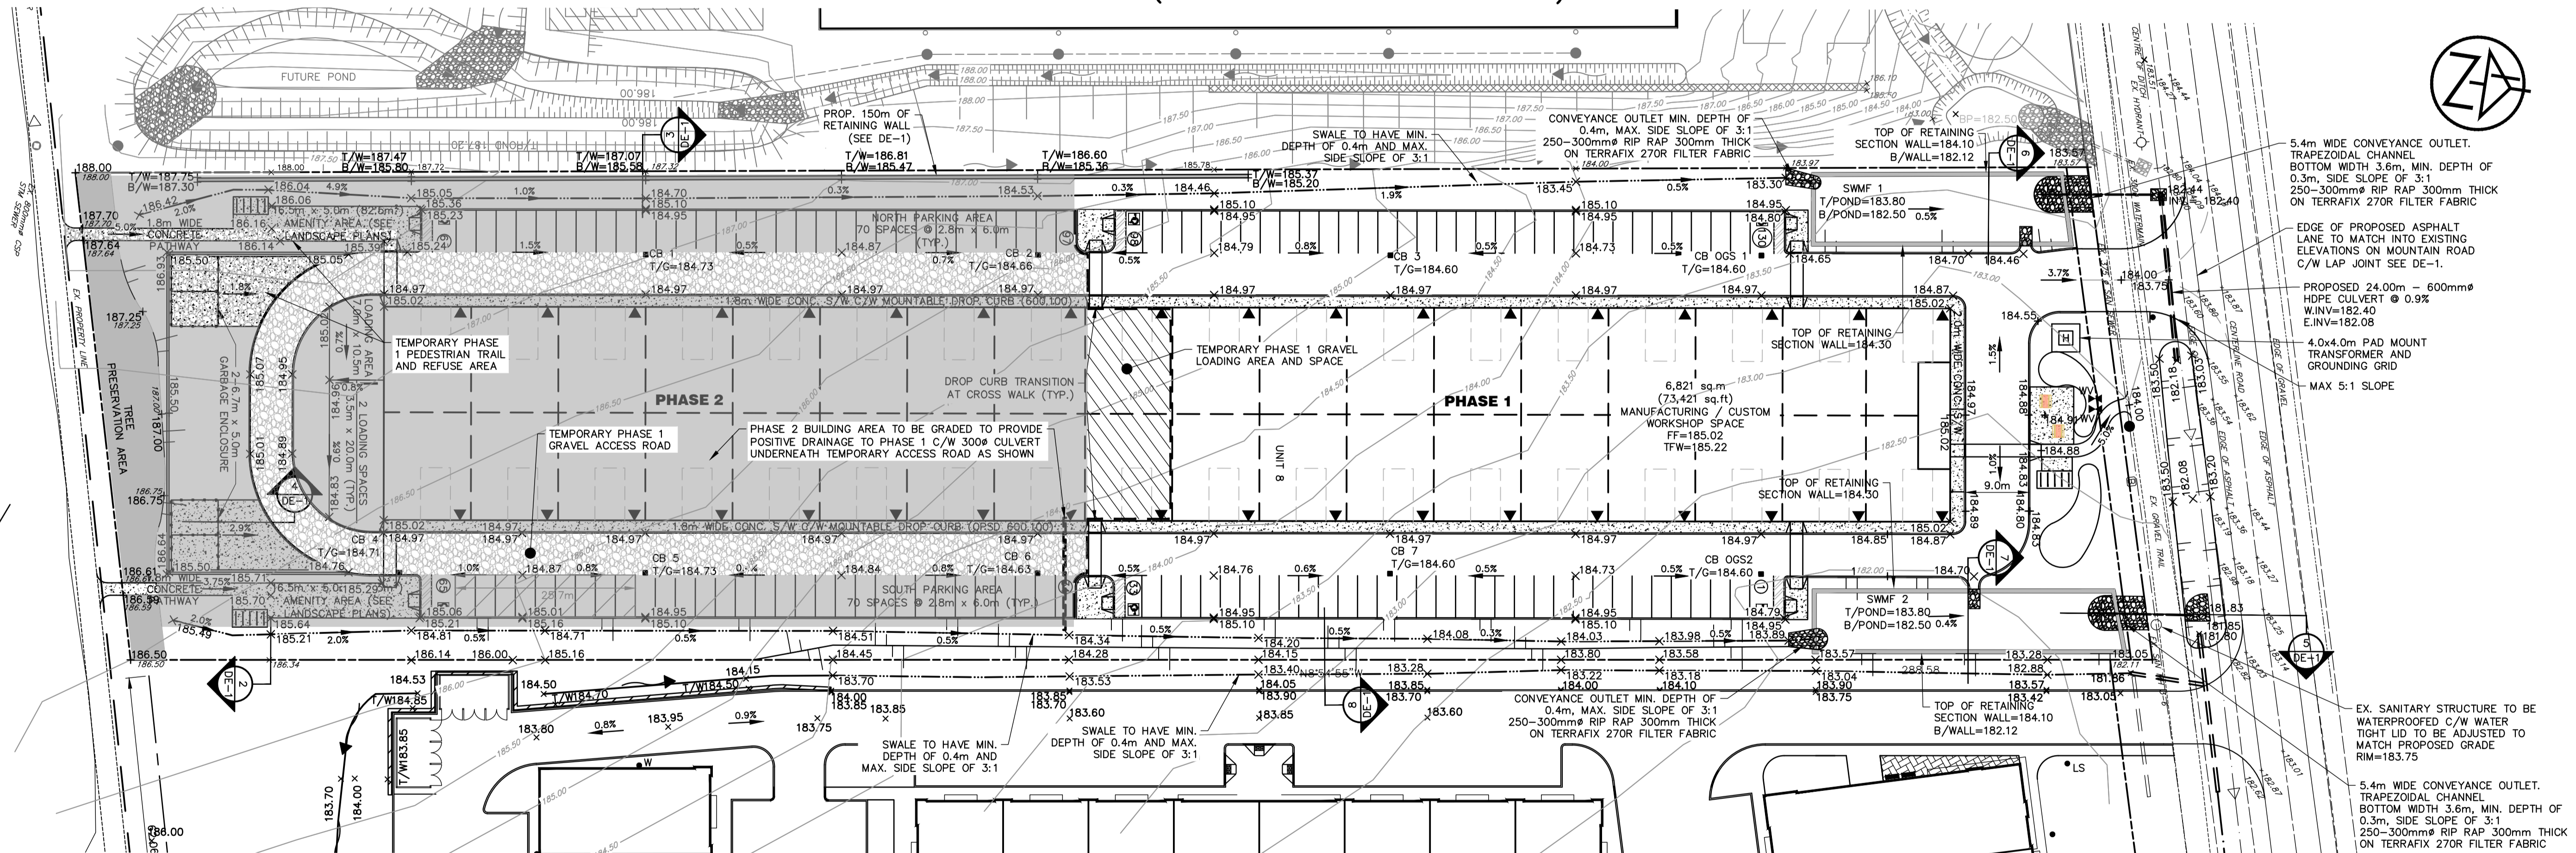

120 MOUNTAIN ROAD (APPROVED)

ACCEPTED FOR
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5.	SUBMISSION 4A	APR 23/24

ENGINEER STAMP

140 MOUNTAIN ROAD
TOWN OF COLLINGWOOD

SITE GRADING PLAN

TATHAM ENGINEERING
 DESIGN: MR/KRL FILE: 121036 DWG:
 DRAWN: MR/KRL DATE: JUN 2022 **SG-1**
 CHECK: KRS SCALE: 1:500

GENERAL CONSTRUCTION

- ALL WORK TO BE CARRIED OUT IN ACCORDANCE WITH TOWN OF COLLINGWOOD STANDARDS, OPSD AND OPSS. WHERE CONFLICT OCCURS, TOWN OF COLLINGWOOD STANDARD TO GOVERN.
- TRENCH BACKFILL TO OPSD 802.010 TO BE SELECT NATIVE MATERIAL OR IMPORTED SELECT SUBGRADE TO OPSS 1010. BACKFILL TO BE PLACED IN MAXIMUM 200 mm THICK LIFTS AND COMPACTED TO 95% OF THE MATERIAL'S STANDARD PROCTOR MAXIMUM DRY DENSITY (SPMDD).
- PIPE BEDDING TO BE GRANULAR 'A', PIPE COVER TO BE GRANULAR 'B' MAX. AGGREGATE SIZE 25mm FOR RIGID PIPE AND GRANULAR 'A' FOR FLEXIBLE PIPE. (MINIMUM BEDDING DEPTH 150 mm, MINIMUM COVER 300mm, COMPACTED TO A MINIMUM 95% SPMDD).
- CLEAR STONE WRAPPED IN FILTER FABRIC CAN BE SUBSTITUTED FOR EMBEDMENT MATERIAL IF APPROVED BY THE ENGINEER.
- ALL MAINTENANCE HOLES ARE 1200 mm DIAMETER UNLESS OTHERWISE SPECIFIED.
- ALL TOPSOIL AND EARTH EXCAVATION TO BE STOCK PILED OR REMOVED AS PER OPSS.MUNI 150 MAINTENANCE AND DISPOSAL OF EXCESS MATERIAL TO AN APPROVED SITE AS DIRECTED BY ENGINEER.
- THE OWNER'S ENGINEER SHALL PROVIDE A SURVEY BENCHMARK ELEVATION FOR USE ON SITE. THE CONTRACTOR SHALL BE RESPONSIBLE FOR ESTABLISHING HORIZONTAL CONTROL AND COMPLETING ALL DETAILED LAYOUT OF THE WORK.
- ALL PROPERTY BARS TO BE PRESERVED AND REPLACED BY O.L.S. AT CONTRACTOR'S EXPENSE IF DAMAGED OR REMOVED DURING CONSTRUCTION.
- ALL MAINTENANCE HOLE AND CATCHBASIN FRAMES AND COVERS TO BE SET TO BASE COURSE HLB ASPHALT ELEVATION AND RAISED PRIOR TO PLACEMENT OF FINAL COURSE HLB ASPHALT.
- THE CONTRACTOR SHALL MAKE HIS OWN ARRANGEMENTS FOR THE SUPPLY OF TEMPORARY WATER AND POWER.
- DEWATERING TO BE CARRIED OUT IN ACCORDANCE WITH OPSS.MUNI 517 AND 518 TO MAINTAIN ALL TRENCHES IN A DRY CONDITION.
- ALL ENGINE DRIVEN PUMPS TO BE ADEQUATELY SILENCED, SUITABLE FOR OPERATION IN A RESIDENTIAL DISTRICT.
- ALL DISTURBED AREAS TO BE REINSTATED TO PREVIOUS CONDITION OR BETTER.
- THE CONTRACTOR IS RESPONSIBLE FOR PRESERVATION OF ALL EXISTING FACILITIES AS WELL AS NOTIFYING ALL UTILITY COMPANIES PRIOR TO COMMENCING WORK AND COORDINATE CONSTRUCTION ACCORDINGLY.
- ALL SIGNAGE TO BE LAWFULLY ERECTED AND MAINTAINED IN ACCORDANCE TO THE TOWN SIGN BY-LAW.
- CLEARING, GRUBBING AND REMOVAL OF SURFACE BOULDERS TO MUNI.OPSS 201.
- GRADING AS PER OPSS.MUNI 206.
- COMPACTION AS PER OPSS.MUNI 501.
- DUST SUPPRESSANTS TO OPSS.MUNI 506.
- TREE REMOVALS AND/OR TRANSPLANTS TO BE COMPLETED OUTSIDE OF MIGRATORY BIRDS NESTING SEASON FROM APRIL 1ST TO AUGUST 31ST. REMOVALS MAY TAKE PLACE DURING THIS RESTRICTED TIME ONLY IF THE REQUIREMENTS OF MIGRATING BIRDS CONVENTION ACT ARE MET AND NESTING ACTIVITY IS ROUTINELY MONITORED BY QUALIFIED INDIVIDUALS (I.E. WILDLIFE BIOLOGIST).

SANITARY SEWERS

- MAINTENANCE HOLES INSTALLED AS PER OPSD 701.010 AND 701.030
- MAINTENANCE HOLD BENCHING AS PER OPSD 701.021
- MAINTENANCE HOLE ACCESS STEPS AS PER OPSD 405.010.
- FROST STRAPS SHALL BE INSTALLED ON ALL MAINTENANCE HOLES AS PER OPSD 701.100
- FRAMES AND COVERS AS PER OPSD 401.030 (SANITARY STRUCTURE TO BE WATER TIGHT)
- PIPE SUPPORT AT MAINTENANCE HOLES AS PER OPSD 708.020.
- ALL MAINTENANCE HOLES, UNLESS EXPRESSLY IDENTIFIED ARE 1200 mm DIAMETER AND TO BE WATER TIGHT.
- GENERAL INSTALLATION AND TESTING OF SEWERS AND APPURTENANCES TO BE IN ACCORDANCE WITH OPSS.MUNI: 407, 408, 409, 410, 421 AND ALL SPECIFICATIONS REFERENCED WITHIN THESE SECTIONS.
- SERVICE CONNECTION TO BE 200 mm DIA., TERMINATED WHERE SPECIFIED ON THE DRAWING COMPLETE WITH PLUG AND MARKED WITH A 38mm X 89mm POST PAINTED GREEN FROM THE INVERT OF THE SERVICE TO MIN. 600 mm ABOVE GRADE.
- SERVICE CONNECTION TO OPSD 1008.010, GRANULAR A BEDDING AND EMBEDMENT.
- RIGID BOARD INSULATION (HI-40 OR APPROVED EQUAL) REQUIRED FOR ALL STORM SEWERS AND SUBDRAINS TO BE PROVIDED AS PER OPSD 1109.030 WHERE MINIMUM FROST COVER OF 1.2 m IS NOT ACHIEVED. INSULATION TO BE A MIN. OF 50mm WITH A MIN. WIDTH OF 1.2m

MATERIALS

- SANITARY SEWER TO BE SDR 35 PVC, SANITARY SERVICES TO BE SDR 28 PVC
- WATER MAIN TO BE DUCTILE IRON CLASS 52, OR PRESSURE CLASS 350 CEMENT LINED. CONDUCTIVITY CONNECTORS TO BE USED ON ALL JOINTS.
- VALVES TO BE RESILIENT SEATED, RSGV, MECHANICAL JOINT, OPEN LEFT CLOW OR MUELLER WITH 5 SL-48 SLIDING VALVE BOX, TO AWWA C504.
- MECHANICAL JOINT DUCTILE FITTINGS AS PER AWWA/ANSI C153/A21.53.
- RESTRAINTERS TO BE ROMAC CRIPPER RING FOR PIPE SIZES UP TO 300 mm
- LIVE TAP SADDLES TO BE EPOXY COATED C/W STAINLESS STEEL BOLTS.
- LIVE TAP VALVE TO BE RESILIENT SEATED RSGV, LIVE TAPE VALVE, OPEN LE.
- FILTER FABRIC TO BE TERRAFIX 270R OR APPROVED EQUAL.
- PERFORATED SUBDRAINS TO BE 100mm DIA. BIG 'O' OR AS SPECIFIED ON DRAWING WITH GEOTEXTILE FILTER SOCK OR APPROVED EQUAL.
- STORM SEWER TO BE SDR 35 PVC OR SMOOTH WALL HDPE (BOSS 2000 WITH BELL AND SPIGOT AND MIN. PIPE STIFFNESS OF 320kpa OR EQUAL)
- ALL SPECIFIED AGGREGATES TO OPSD 1010.
- INSULATION TO BE STYROFOAM HI-40, MIN. 50MM THICK
- CATCH BASINS AND INLET STRUCTURES TO BE FITTED WITH TEMPORARY LAYFIELD CBST SEDIMENT TRAPS DURING CONSTRUCTION ACTIVITIES AND TO REMAIN IN PLACE UNTIL PLACEMENT OF ASPHALT. TRAPS TO BE CLEANED OUT AS REQUIRED PRIOR TO ASSUMPTION OF THE WORK.

WATERMAIN

- MINIMUM COVER ON WATER SERVICE AND CONNECTIONS TO BE 1.7 m.
- ALL VALVES, BENDS AND FITTINGS TO BE CONNECTED WITH GRIP RING RESTRAINING CLAMP.
- CLEARANCE BETWEEN WATER MAINS / WATER SERVICES AND SEWERS TO BE A MINIMUM OF 0.5m VERTICAL WHERE WATER MAIN IS BELOW SEWER OR 2.5m MINIMUM HORIZONTAL SEPARATION. WHERE WATER MAIN IS ABOVE SEWER, THE MINIMUM SEPARATION TO BE 150 mm (COMPACTED BEDDING MATERIAL).
- GENERAL INSTALLATION AND TESTING OF WATER MAIN AND APPURTENANCES TO BE IN ACCORDANCE WITH OPSS.MUNI 441 AND ALL SPECIFICATIONS REFERENCED WITHIN THESE SECTIONS.
- RIGID BOARD INSULATION (HI-40) REQUIRED FOR FROST PROTECTION OF WATER MAIN / SERVICE WITH LESS THAN 1.7m MINIMUM COVER. INSULATION TO BE MINIMUM 50mm THICK AND HAVE A MINIMUM WIDTH OF 1.2m FOR EVERY 0.3m OF COVER LESS THAN 1.7m. MAXIMUM DEPTH OF INSULATION TO BE 100mm.
- ALL WORK ON TOWN PROPERTY AND ON TOWN OF COLLINGWOOD WATER DEPARTMENT (TCWD) WATER MAINS MUST BE UNDERTAKEN BY TCWD OR AN APPROVED CONTRACTOR WITH TCWD INSPECTION AT DEVELOPER'S EXPENSE.
- CATHODIC PROTECTION TO INCLUDE SACRIFICIAL ZINC CAPS ON ALL FITTING BOLTS.
- WATERMAIN SERVICE CONNECTIONS AS PER OPSS.MUNI 441, 150 mm GRANULAR 'A' EMBEDMENT AND COVER OVER PIPE. TERMINATE WHERE SPECIFIED ON DRAWING C/W GATE VALVE AT PROPERTY LINE, PROVIDED TESTING TAIL TO SURFACE ATTACHED TO A 38mm x 89mm MARKER POST AND APPROVED BLUE FROM THE INVERT OF THE SERVICE TO MIN 600 mm ABOVE GRADE.
- SERVICE TO BE CONSTRUCTED IN ACCORDANCE WITH TOWN STANDARDS.
- WATER MAIN SERVICES - 50mm TYPE K COPPER, MAIN STOPS TO 201-A3H3, 3/4", BALL STYLE. AWWA THREAD BY COMPRESSION CAMBRIDGE BRASS. CURB STOPS TO 203-H3H3, 3/4" BALL STYLE WITH DRAIN, COMPRESSION JOINT CAMBRIDGE BRASS. SERVICE BOXES TO NUMBER 7, D-1 CLOW OR MUELLER WITH 24" BLACK RODS STRAIGHT OR OTHERWISE NOTED ON DRAWINGS.
- ALL WATERMAIN DISINFECTION WILL BE CONDUCTED BY THE DEVELOPER IN ACCORDANCE WITH THE MECP WATERMAIN DISINFECTION PROCEDURE, AT THE DEVELOPER'S COST, TO THE SATISFACTION OF THE TOWN. THE TOWN SHALL COLLECT THE REQUIRED MICROBIOLOGICAL WATER QUALITY SAMPLES, AT THE DEVELOPER'S COST, PRIOR TO PLACING THE WATERMAIN INTO SERVICE. A WATER COMMISSIONING PLAN SHOULD BE SUBMITTED TO THE TOWN'S WATER DEPARTMENT A MINIMUM OF 2 WEEKS PRIOR TO COMMENCING ANY TESTING OR REVIEW AND APPROVAL.
- AS A GENERAL PRINCIPLE EACH PROPERTY SHALL HAVE ONE SERVICE AND ONE METER. ADDITIONAL METERS CAN BE ADDED INTERNALLY TO MEASURE THE WATER USE FOR EACH BUILDING. HOWEVER, THE MUNICIPALITY WILL HAVE ONE METER, CONNECTED TO ONE WATER BILL.
- NO WATER VALVES ARE TO BE OPERATED WITHOUT TCWD APPROVAL.

ASPHALT AND CONCRETE AREAS















- SUBGRADE AND ALL GRANULAR 'A' MATERIAL TO BE COMPACTED TO A MINIMUM DRY DENSITY OF AT LEAST 98% SPMDD. SUBGRADE TO BE PROOF ROLLED AND CERTIFIED PRIOR TO PLACING GRANULAR 'B'.
- GRANULAR 'A' AND 'B' BASE TO BE COMPACTED TO 100% OF THE MATERIAL'S RESPECTIVE SPMDD.
- ASPHALT AREAS TO BE CONSTRUCTED WITH MIN. 300 mm GRANULAR 'B', 50 mm HLB AND 40mm HL3. ALL SUBDRAINS TO BE CONSTRUCTED IN ACCORDANCE WITH OPSS.MUNI 405.
- CONCRETE BARRIER CURB TO OPSD 600.110. CONCRETE MOUNTABLE CURB TO OPSD 600.100.
- SELECT SUBGRADE MATERIAL, OR IMPORTED GRANULAR MATERIAL APPROVED BY THE ENGINEER, COMPACTED TO 98% SPMDD. TO BE USED AS FILL IN ALL AREAS WHERE PROPOSED PIPE INVERTS ARE HIGHER THAN EXISTING GRADE OR AS INSTRUCTED BY THE ENGINEER.
- ALL GRANULAR AND ASPHALT MATERIALS TO BE PLACED AND COMPACTED IN ACCORDANCE WITH OPSS.MUNI 314 AND OPSS.MUNI 310
- JOINTS WITH EXISTING ASPHALT TO BE SAW CUT STRAIGHT PRIOR TO PLACING NEW ASPHALT. WHERE EXISTING ASPHALT IS THICKER THAN 75 MM, A 300 MM WIDE BY 40 MM DEEP LAP JOINT SHALL BE GROUND INTO EXISTING ASPHALT PRIOR TO THE PLACEMENT OF SURFACE COURSE ASPHALT (SEE DETAIL).
- REINSTATEMENT OF ALL DISTURBED BOULEVARDS TO INCLUDE REGRADING, MINIMUM 150mm TOPSOIL AND 500 TO OPSS.MUNI 802 AND 803.
- ENTRANCES AS PER OPSD 350.010, SIDEWALKS TO OPSD 310.050, 310.010, 310.039 AND ADDA STANDARDS.
- CONCRETE PATHWAYS TO STD #1120.

STORM SEWERS

- MAINTENANCE HOLES AND CBMH AS PER OPSD 701.010 AND 701.030.
- CATCHBASINS AS PER OPSD 705.010 WITH 600mm SUMP
- CATCHBASIN FRAMES AND GRATES AS PER OPSD 400.020.
- PIPE SUPPORT AT CB'S, CBMH'S, MH'S AS PER OPSD 708.020.
- CATCH BASINS AND INLET STRUCTURES FITTED WITH SEDIMENT TRAPS DURING CONSTRUCTION ACTIVITIES, AND CLEANED OUT AS REQUIRED PRIOR TO ASSUMPTION OF THE WORK.
- RIGID BOARD INSULATION (HI-40 OR APPROVED EQUAL) REQUIRED FOR ALL STORM SEWERS AND SUBDRAINS TO BE PROVIDED AS PER OPSD 1109.030 WHERE MINIMUM FROST COVER OF 1.2 m IS NOT ACHIEVED. INSULATION TO BE A MIN. OF 50mm WITH A MIN. WIDTH OF 1.2m

GENERAL NOTES

- POSTS SHALL BE CONNECTED TO PRECAST BLOCKS.
- ANCHORS SHALL BE INSTALLED ACCORDING TO MANUFACTURER'S SPECIFICATIONS.
- POSTS AND RAILINGS SHALL BE HOT DIP GALVANIZED ACCORDING TO ASTM A123 AFTER FABRICATION.
- POSTS SHALL BE VERTICAL. ALL EXPOSED CORNERS SHALL BE GROUND SMOOTH.
- WELDING SHALL BE ACCORDING TO CSA W59.
- PROVIDE TWO COATS OF GALVAFROID FOR ALL JOINTS THAT ARE FIELD WELDED.
- ALL STEEL SHALL BE ASTM A500 GRADE C. (BLACK)
- CONTRACTOR IS TO VERIFY ALL DRAWING MEASUREMENTS IN THE FIELD.
- PEDESTRIAN GUARD HAS BEEN DESIGNED IN ACCORDANCE WITH OBC 4.1.5.14 - LOADS ON GUARDS. (BLACK)

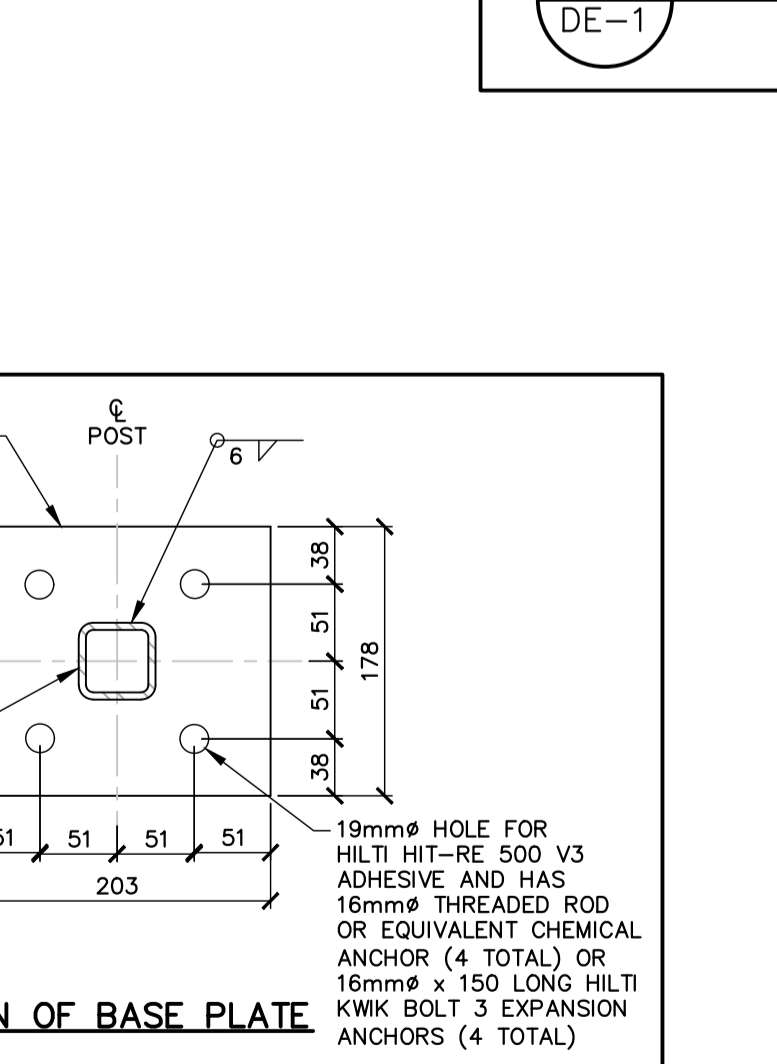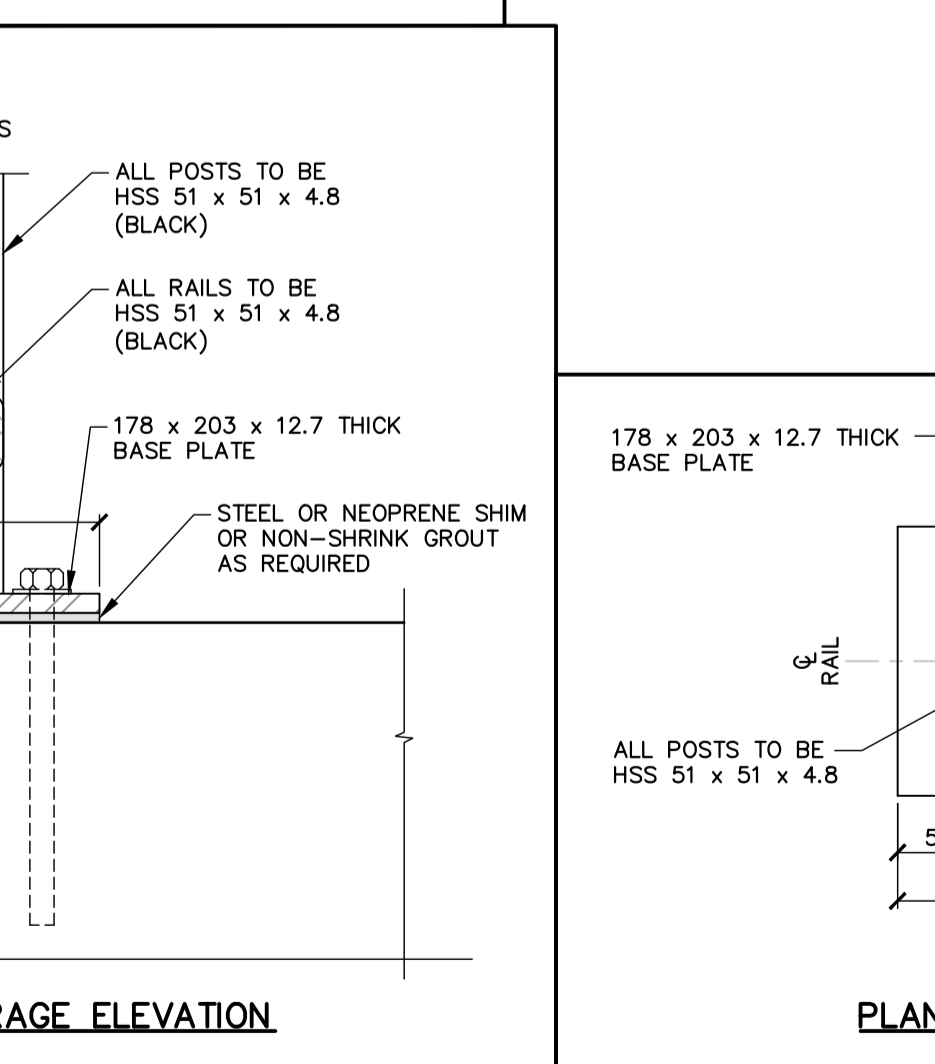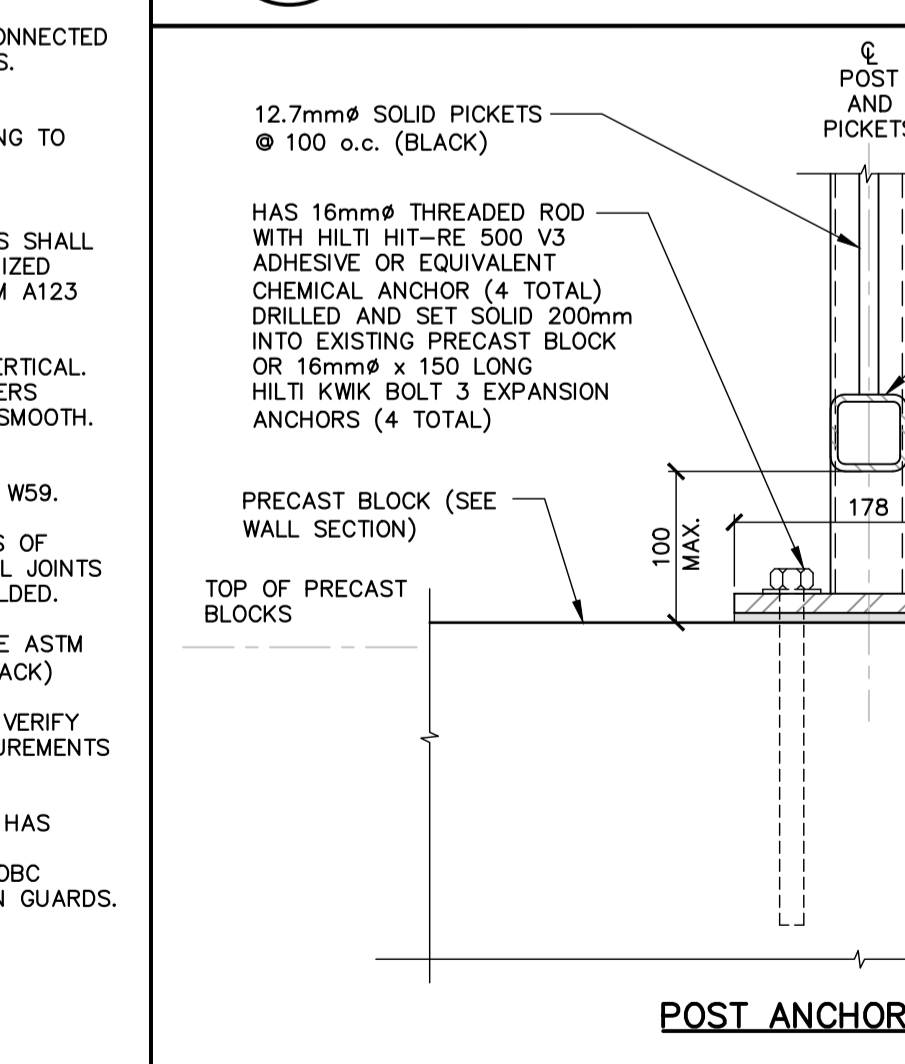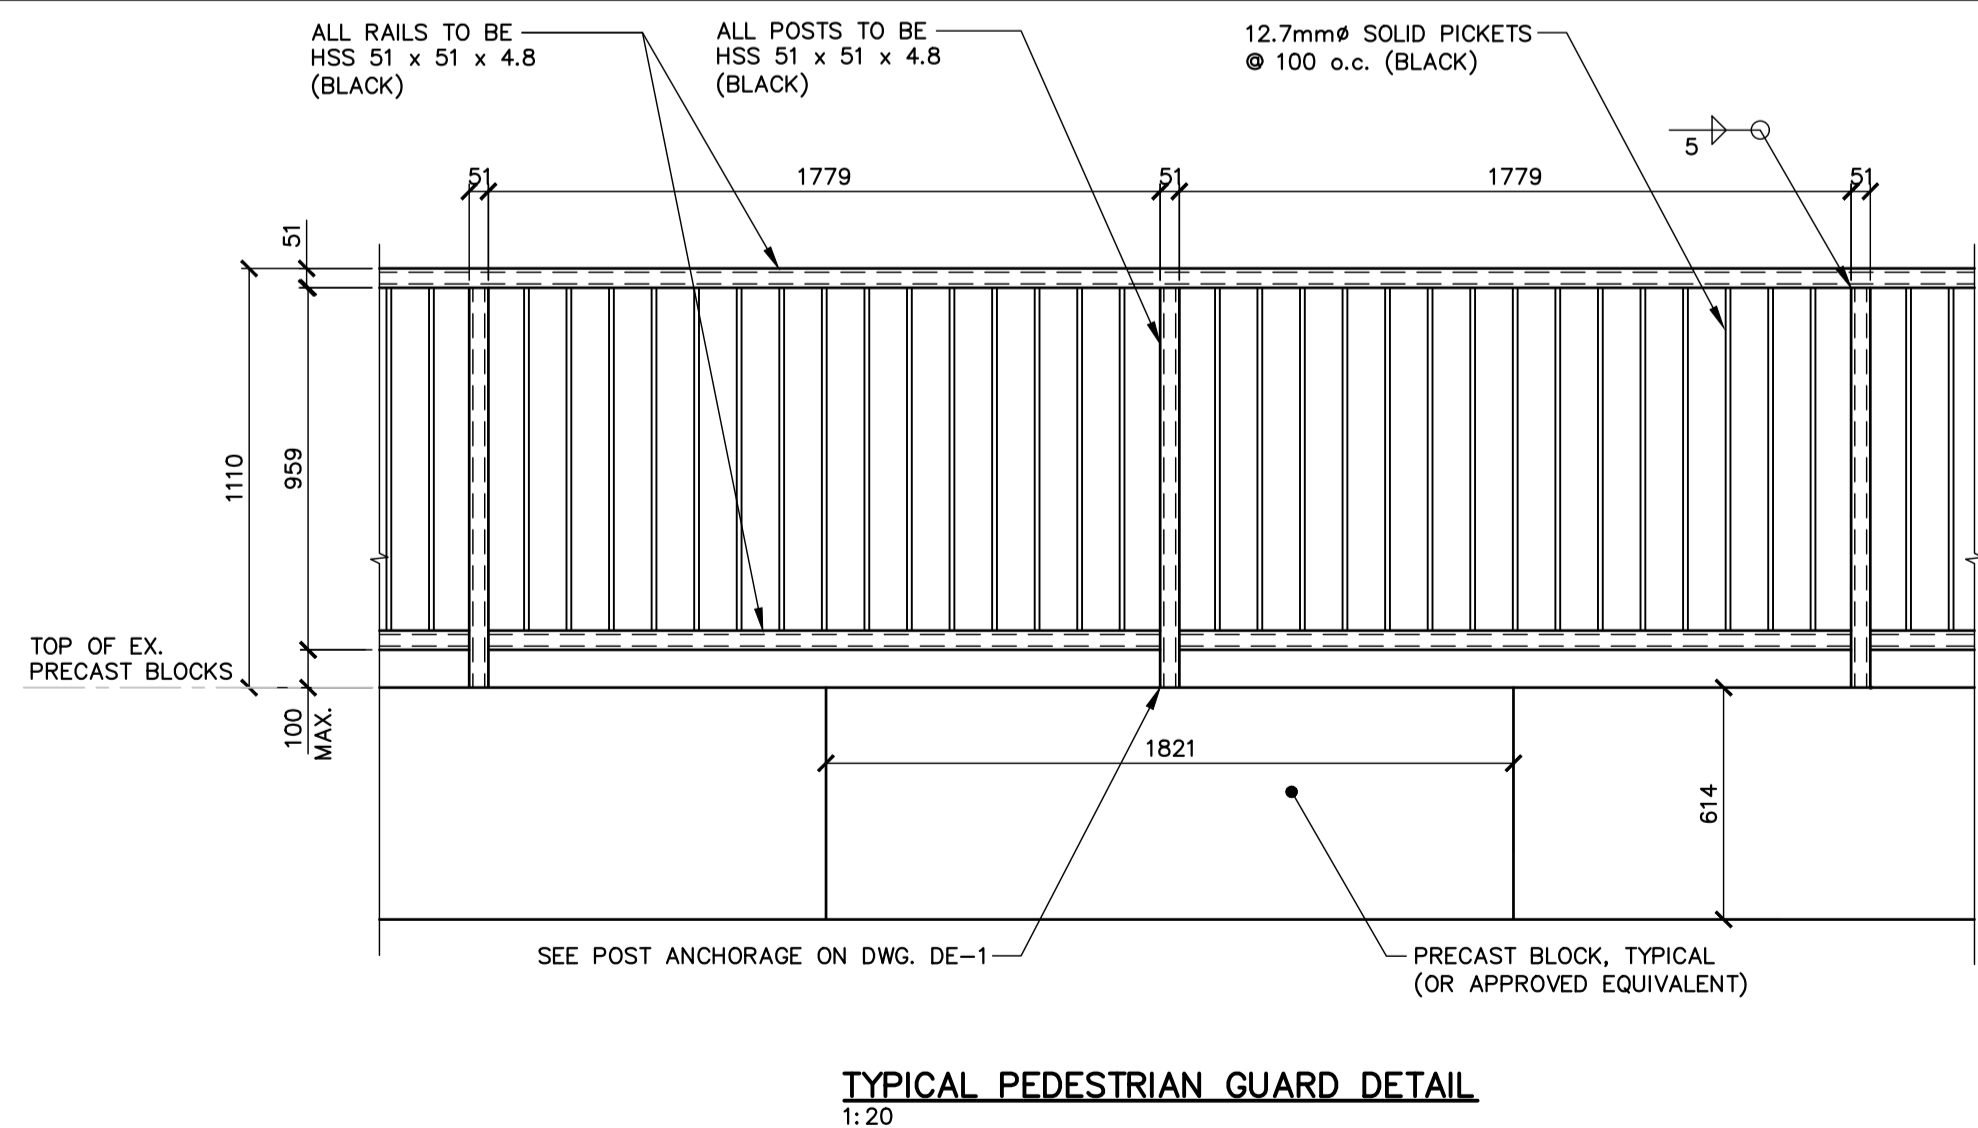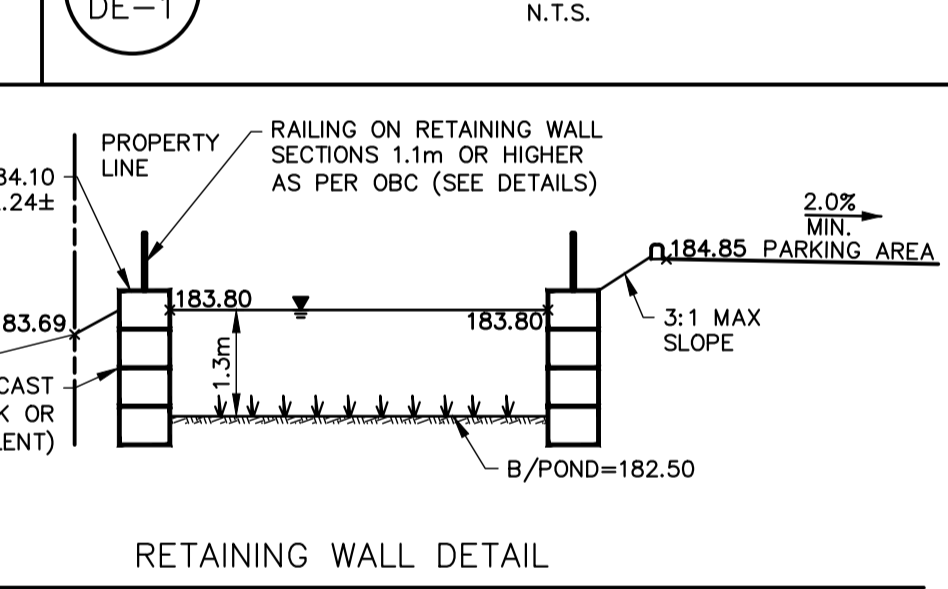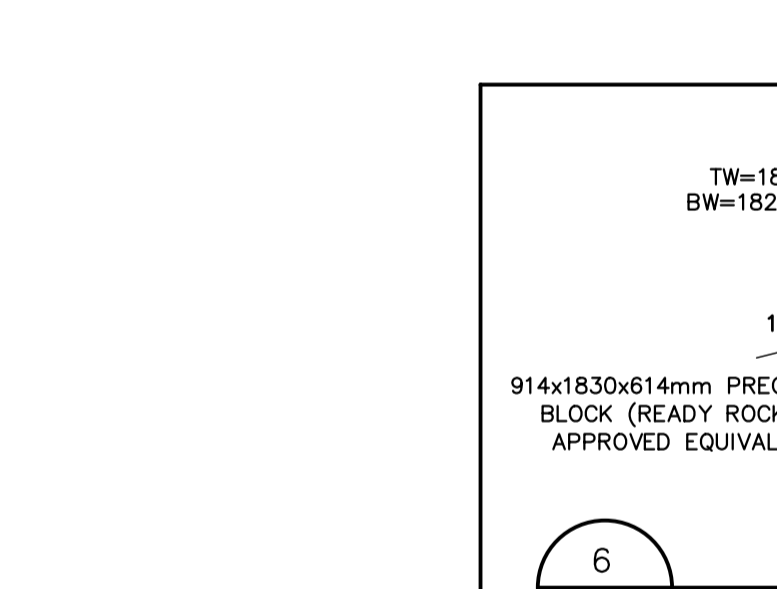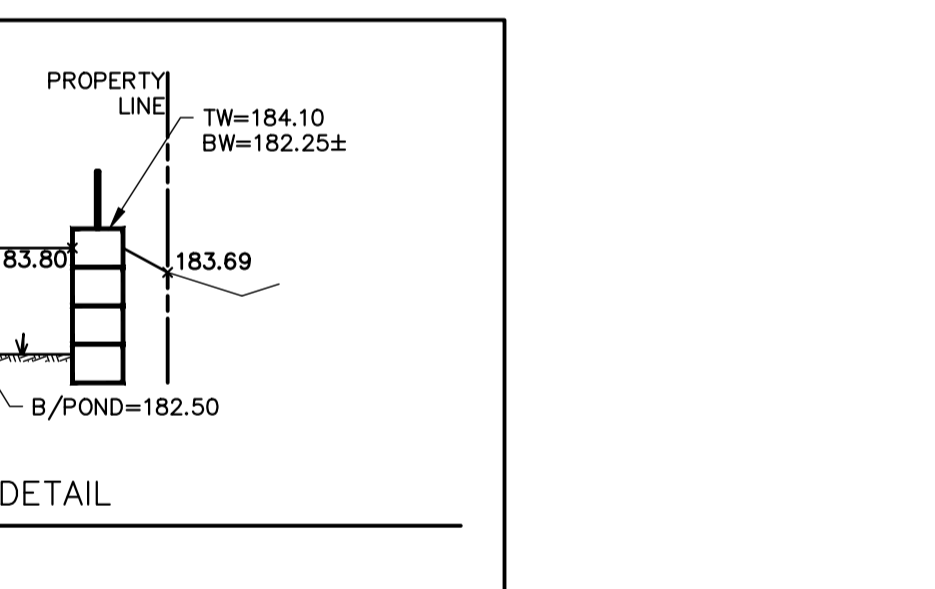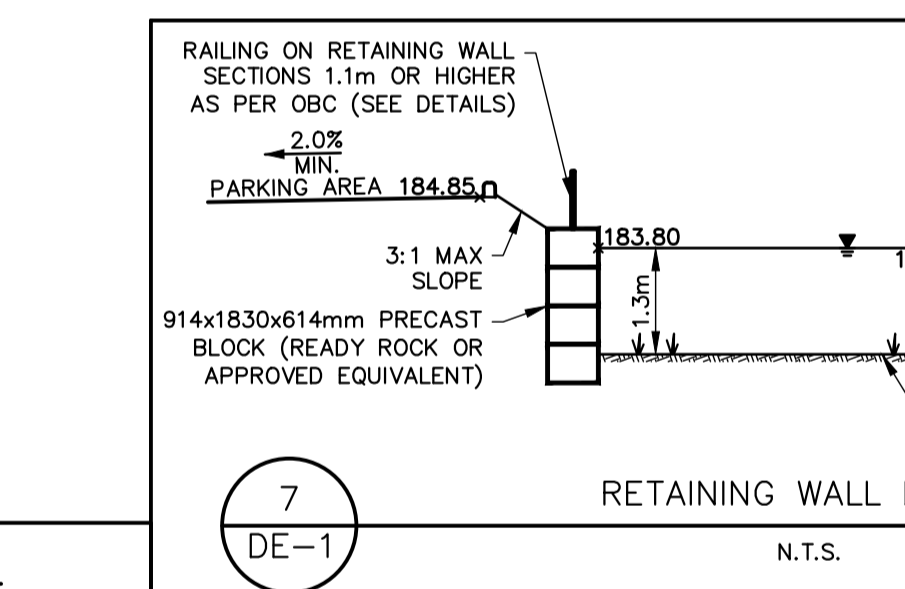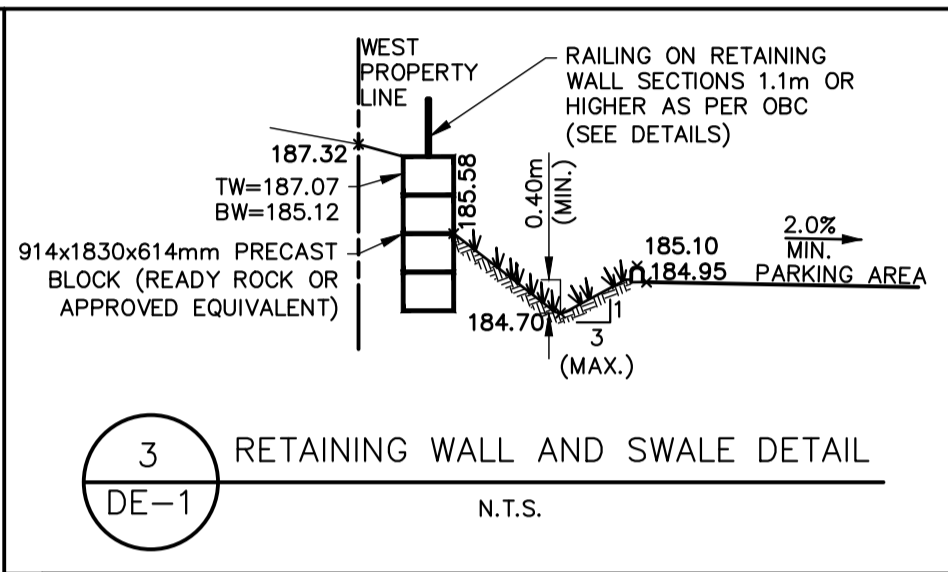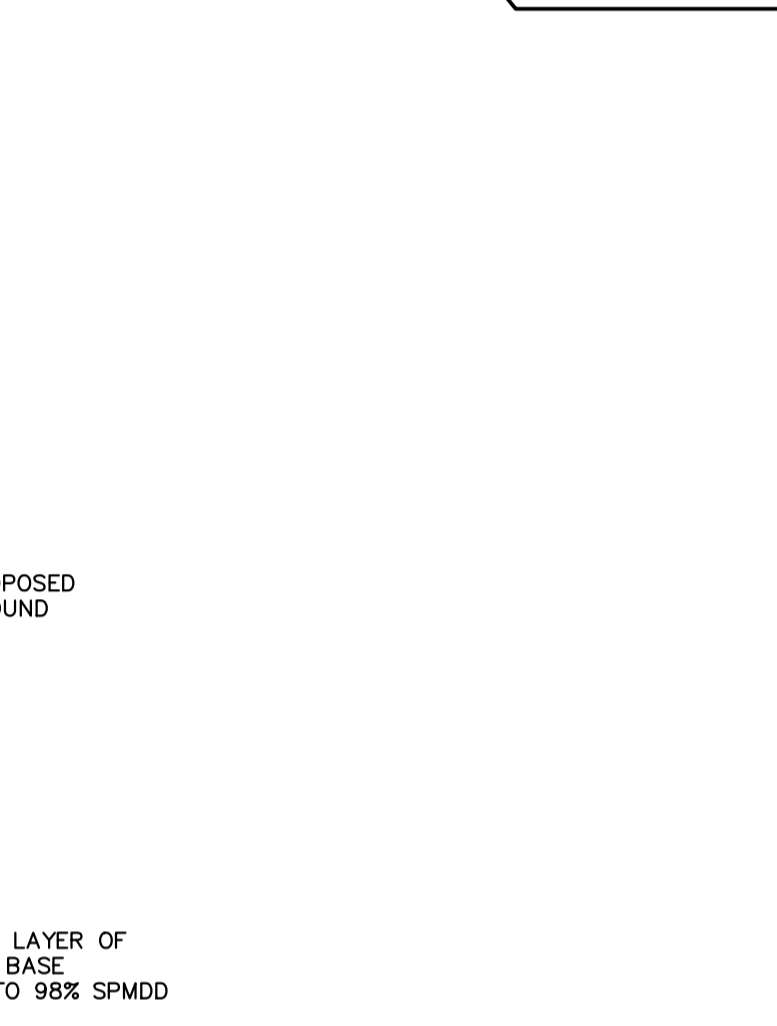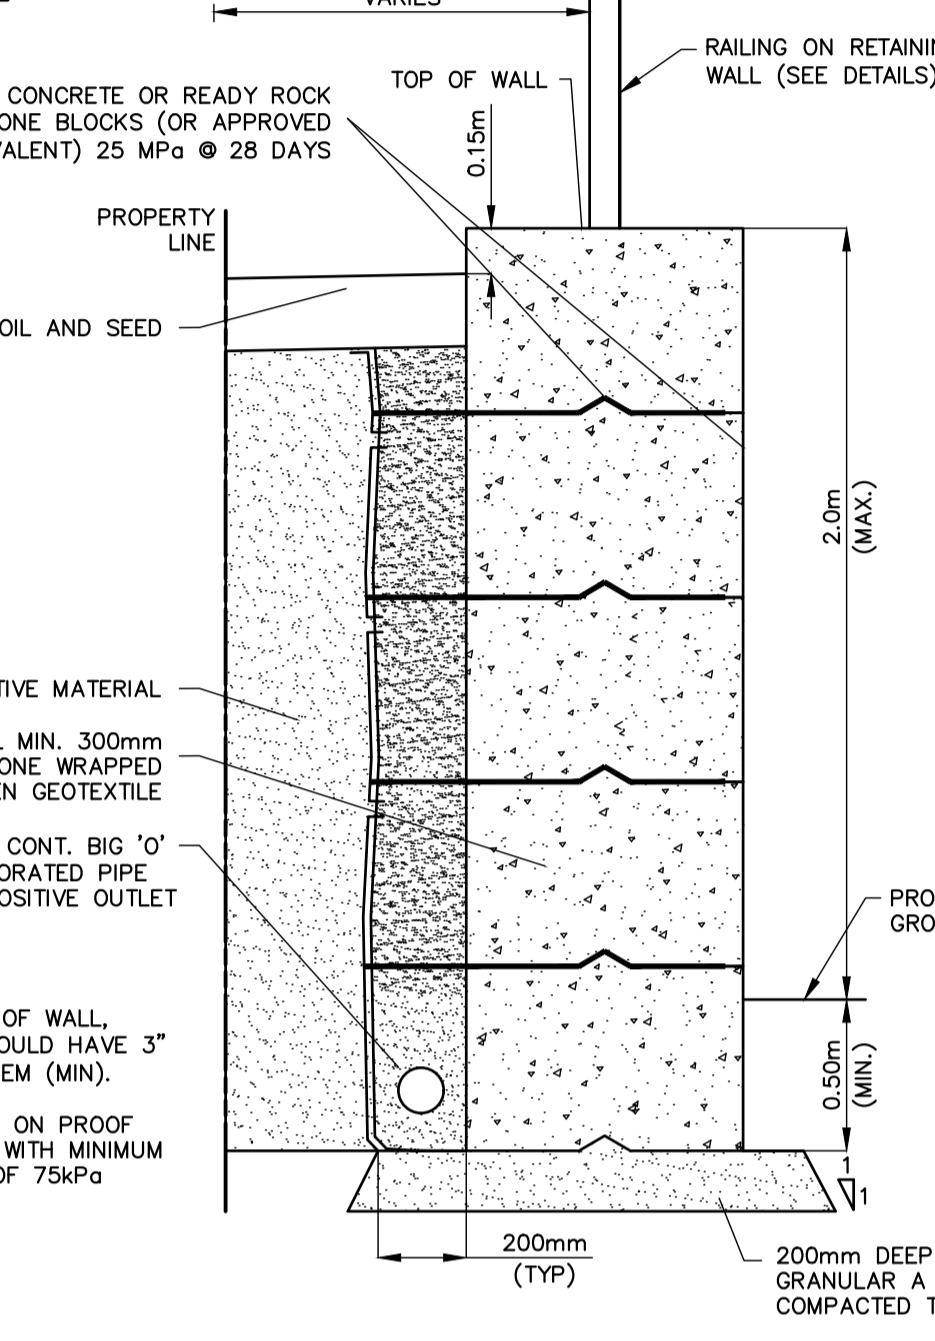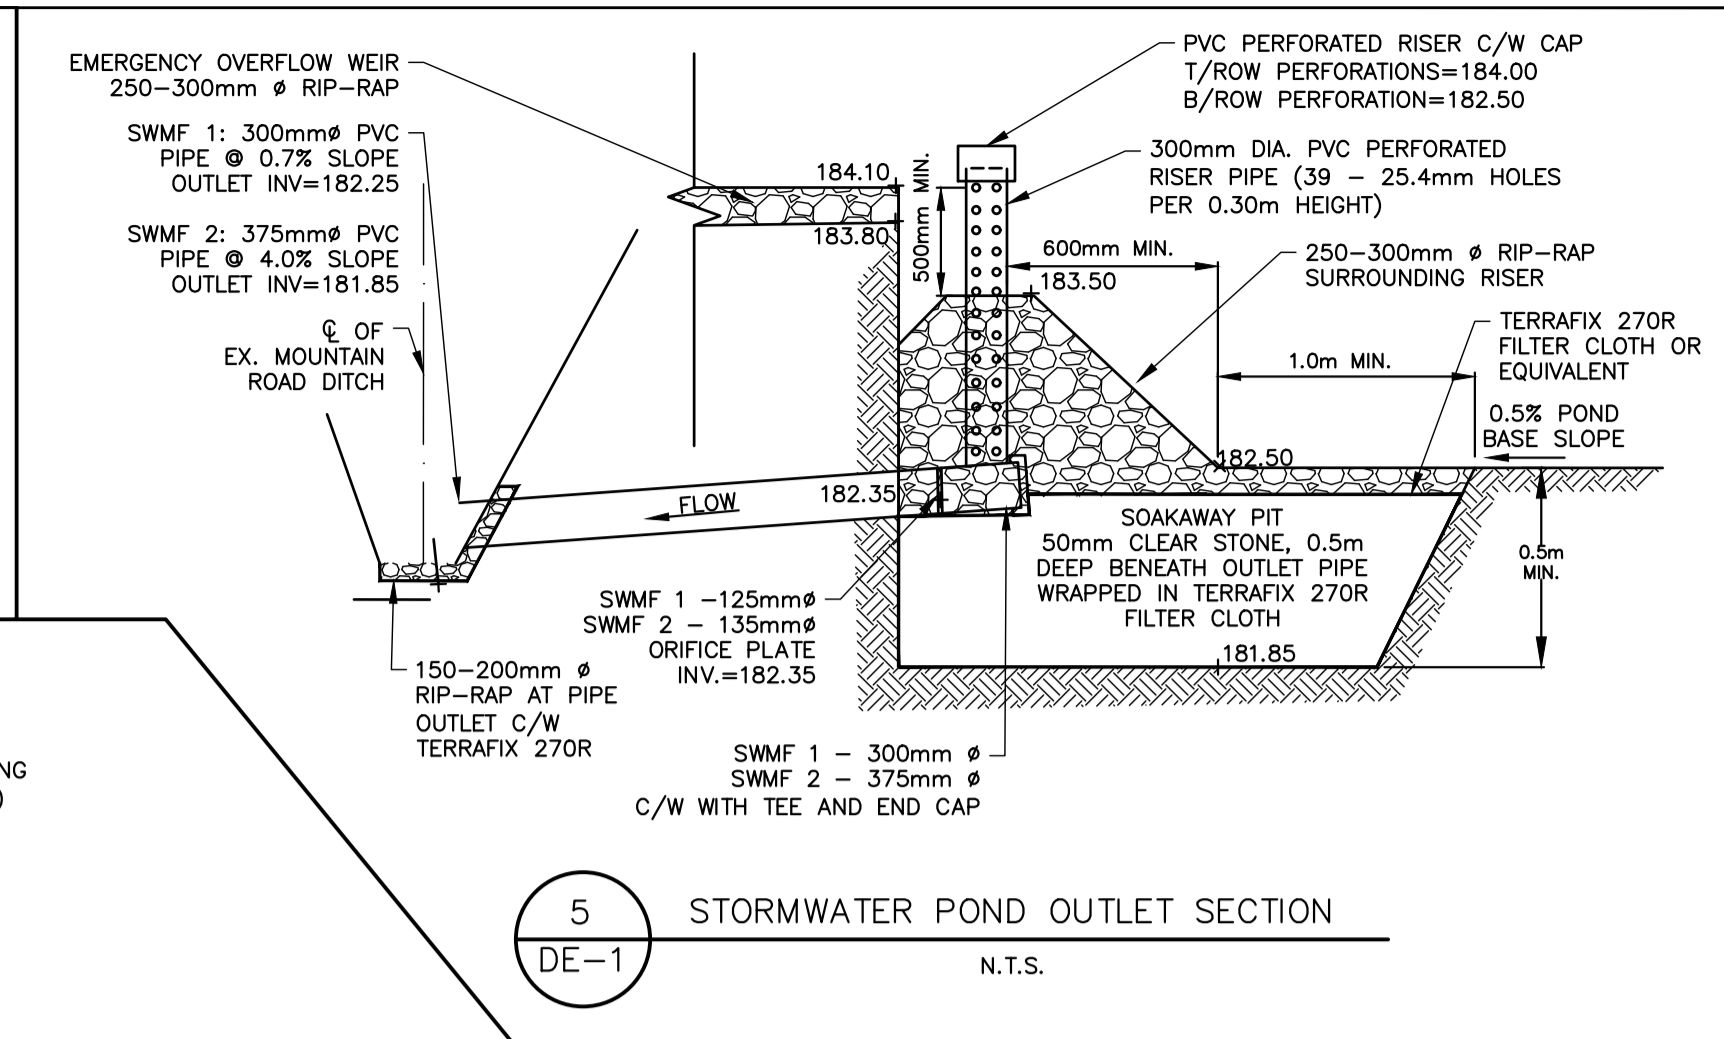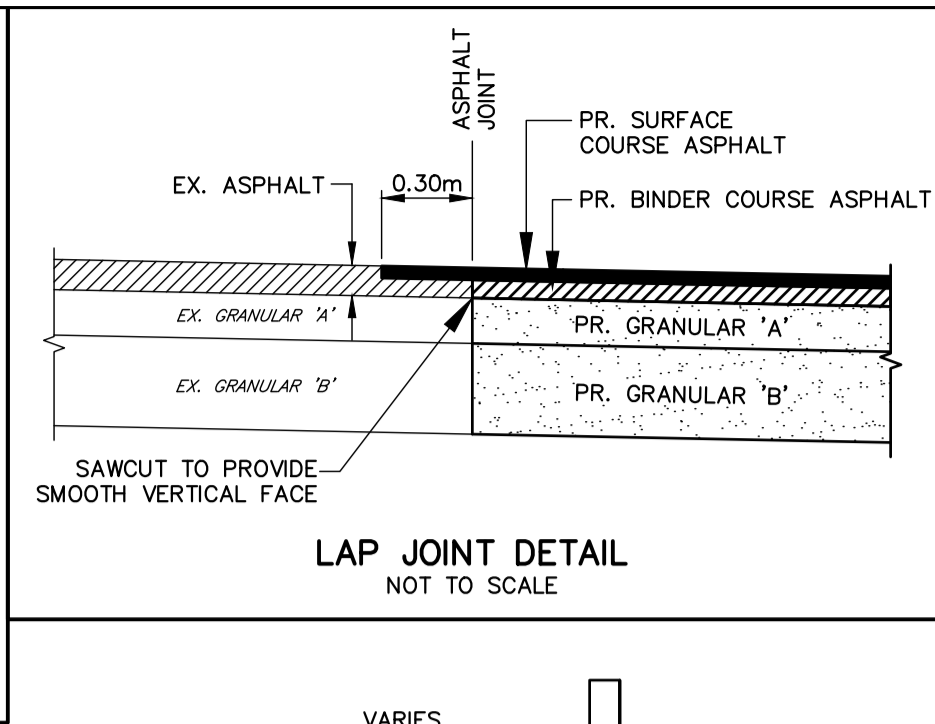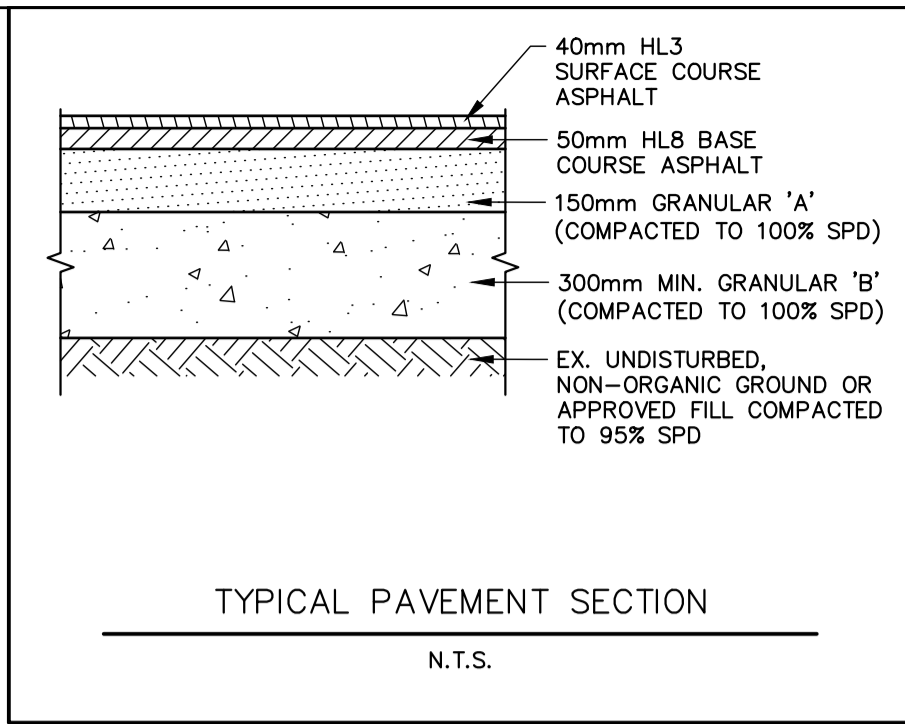

ACCEPTED FOR CONSTRUCTION TOWN OF COLLINGWOOD

PER _____


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DISCLAIMER AND COPYRIGHT
 CONTRACTOR MUST VERIFY ALL DIMENSIONS AND BE RESPONSIBLE FOR SAME. ANY DISCREPANCIES MUST BE REPORTED TO THE ENGINEER BEFORE COMMENCING WORK. DRAWINGS ARE NOT TO BE SCALED.
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BENCHMARKS
 TB2 - ELEVATION 189.765
 NAIL & WASHER ON NORTH FACE OF HYDRO POLE LOCATED ON NORTH SIDE OF MOUNTAIN ROAD JUST WEST OF EXISTING ACCESS TO SITE.

NOTES
 LEGAL INFORMATION SHOWN FROM REGISTERED PLAN 51R-41847 BY ZUBEK, EMO, PATTEN & THOMSEN LIMITED, DATED NOVEMBER 16, 2018 AND SIGNED BY PAUL R. THOMSEN.

No.	REVISION DESCRIPTION	DATE	ENGINEER STAMP
1.	FIRST SUBMISSION	DEC 21/22	
2.	SECOND SUBMISSION	DEC 21/23	
3.	THIRD SUBMISSION	JAN 26/24	
4.	FOURTH SUBMISSION	APR 4/24	
5.	SUBMISSION 4A	APR 23/24	



140 MOUNTAIN ROAD TOWN OF COLLINGWOOD

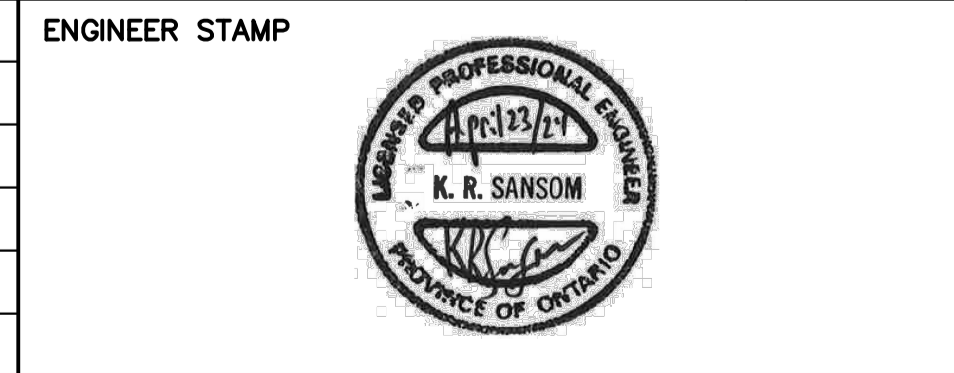DETAILS AND NOTES

DESIGN: MR/KRL	FILE: 121036	DWG: DE-1
DRAWN: MR/KRL	DATE: JUN 2022	
CHECK: KRS	SCALE: NTS	